


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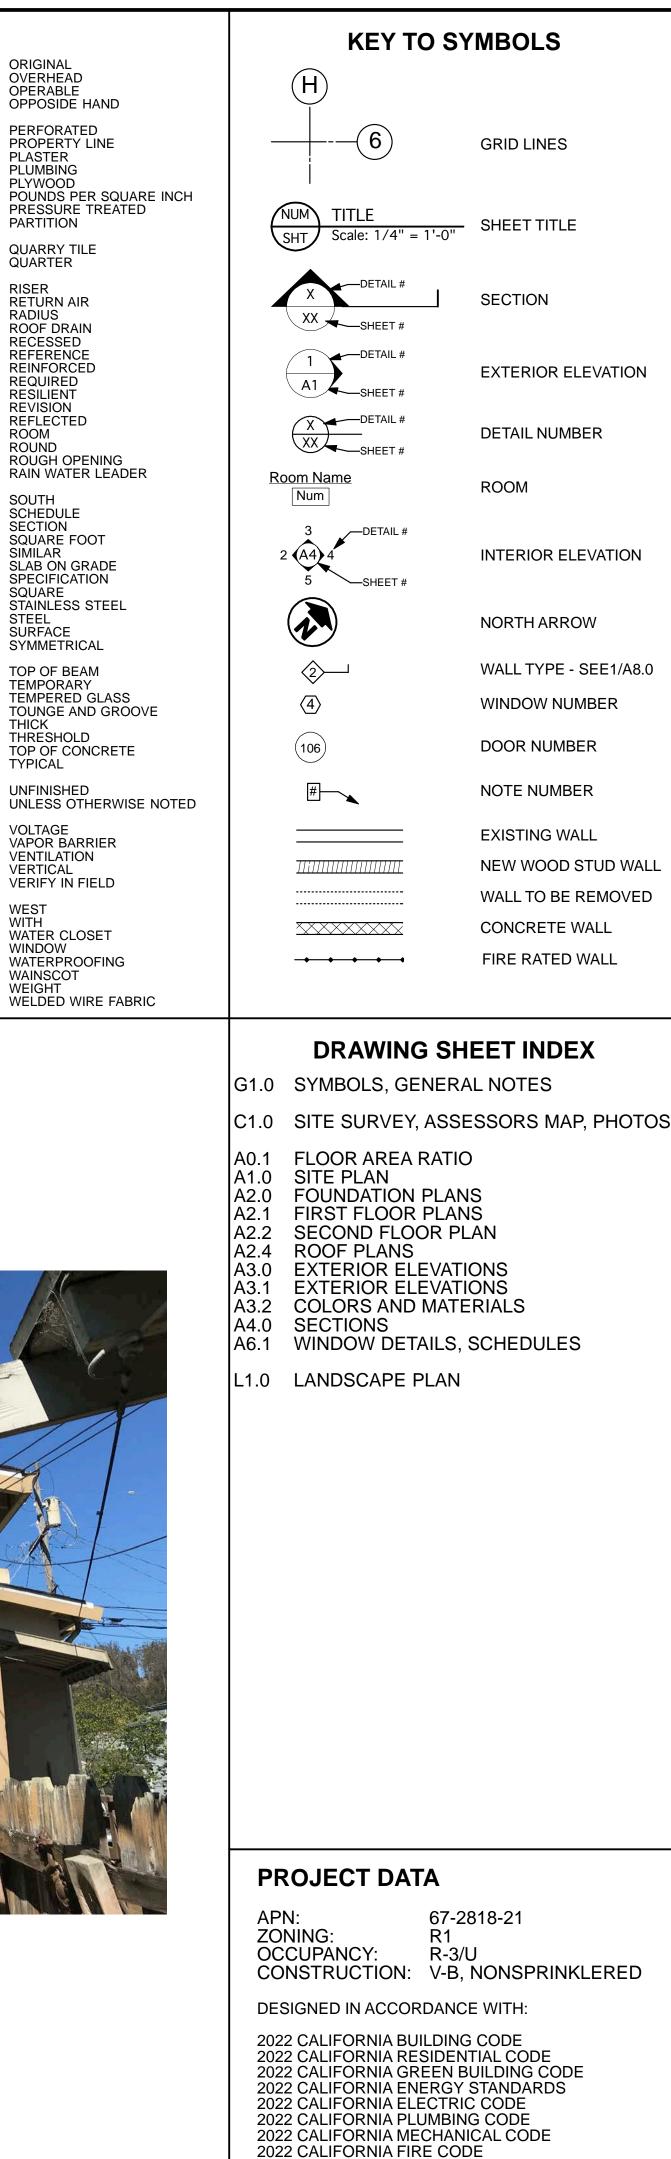
625 EVELYN AVENUE - FRONT



PROJECT DIRECTORY	ABBREVIATIONS				
OWNER: SHERI LEUNG AND LIEM TRUONG 101 JANIE COURT EL CERRITO, CA 94530 PHONE: (510) 685-7344 CONTACT: SHERI LEUNG ARCHITECTURAL: HARTIGAN ARCHITECTURE 1528 VERSAILLES AVENUE ALAMEDA, CA 94501 PHONE: (510) 865-4213 CONTACT: MICHAEL HARTIGAN SURVEY: DMG ENGINEERING INC. 30 OAKVUE COURT PLEASANT HILL, CA 94523 PHONE: (925) 787-0463	AB ABV AC ACC ACT A/C ADJ AFF AGG ALT ALUM AMT APPROX BC BD BFF BLDG BLKG BM BOT BRG	ANCHOR BOLT ABOVE AIR CONDITIONING ACCESS ACOUSTICAL CEILING TILE ASPHALTIC CONCRETE ADJACENT ABOVE FINISHED FLOOR AGGREGATE ALTERNATE ALUMINUM AMOUNT APPROXIMATE BOTTOM OF CURB BOARD BELOW FINISHED FLOOR BUILDING BLOCKING BEAM BOTTOM BEARING	ABE FLR FLUOR FOF FOC FOS FPRF FS FT FTG GA GALV GB GC GL GD GBD HB HDR HDR HDR HDW HGT	FLOOR FLUORESCENT FACE OF FINISH FACE OF CONCRETE FACE OF STUDS FIREPROOFING FIRE SPRINKLER FOOT OR FEET FOOTING GAUGE GALVANIZED GRAB BAR GENERAL CONTRACTOR GLASS GROUND GYPSUM BOARD HOSE BIBB HEADER HARDWARE HEIGHT	ORIG OVHD OPER OPP HD PERF P/L PLAS PLBG PLYWD PSI PT PTN QT QTR R RA RAD RD REC
	BSMT CAB CEM CIP CL CLG CLR CLR CMU CNTR CJ COL COMP CONC	BASEMENT CABINETRY CATCH BASIN CEMENT CAST-IN-PLACE CENTER LINE CEILING CLEAR CONCRETE MASONRY UNIT COUNTER CONTROL JOINT COLUMN COMPOSITE CONCRETE	ID HORIZ HR HTG ID IN INCL INFO INSUL INT INV JST JT	HANDRAIL HORIZONTAL HOUR HEATING INSIDE DIAMETER INCH INCLUDE INFORMATION INSULATION INTERIOR INVERT JOIST JOINT	REF REINF REQD RESIL REV RFL RM RND RO RWL S SCHED SECT SF
SPECIAL INSPECTIONS s Statement of Special Inspections is submitted in fulfillment he requirements of the 2019 California Building Code apter 17.	CONC CONT CORR CPT CT CTR	CONCRETE CONTINUOUS CORRIDOR CARPET CERAMIC TILE CENTER	KO KP L LAM	KNOCKOUT KICK PLATE LENGTH LAMINATE	SF SIM SOG SPEC SQ SS STL
ecial Inspections and Testing will be performed in cordance with the approved plans and specifications, The y of Alameda "Statement of Special Inspection" form and lifornia Building Code Sections 1704 and 1705. ecial inspectors will refer to the approved plans and ecifications for detailed special inspection requirements.	DBL DET DF DIA DIM DN EA EB	DOUBLE DETAIL DRINKING FOUNTAIN DIAMETER DIMENSION DOWN EACH EXPANSION BOLT	LAV LB LIN LNF MAS MATL MAX MB	LAVATORY POUND OR LAG BOLT LINOLEUM LINEAR FOOT (FEET) MASONRY MATERIAL MAXIMUM MACHINE BOLT	SURF SYM TB TEMP TEMP GL T&G THK THRESH
y additional tests and inspections required by the approved ns and specifications will also be performed. e following special inspections are required: •	EJ EL ELEC EMER ENCL ENGR EQ EX EXH EXH EXP EXT	EXPANSION JOINT ELEVATION ELECTRICAL EMERGENCY ENCLOSURE ENGINEER EQUAL EXISTING EXHAUST EXPANSION EXTERIOR	MECH MEMB MFR MIN MISC MO MTL N NA NIC NO	MECHANICAL MEMBRANE MANUFACTURER MINUMUM MISCELLANEOUS MASONRY OPENING METAL NORTH NOT APPLICABLE NOT IN CONTRACT NUMBER	TOC TYP UNFN UNO V VB VENT VERT VIF
	FA FD FDN FE FEC FF FFE FIN	FIRE ALARM FLOOR DRAIN FOUNDATION FIRE EXTINGUISHER FIRE EXTINGUISHER CABINET FINISHED FLOOR FINISHED FLOOR ELEVATIO FINISH(ED)	NOM NTS OC OD OPNG OPP OPT	NOMINAL NOT TO SCALE ON CENTER OUTSIDE DIMENSION OPENING OPPOSITE OPTIONAL	W W/ WC WDW WP WSCT WT WWF

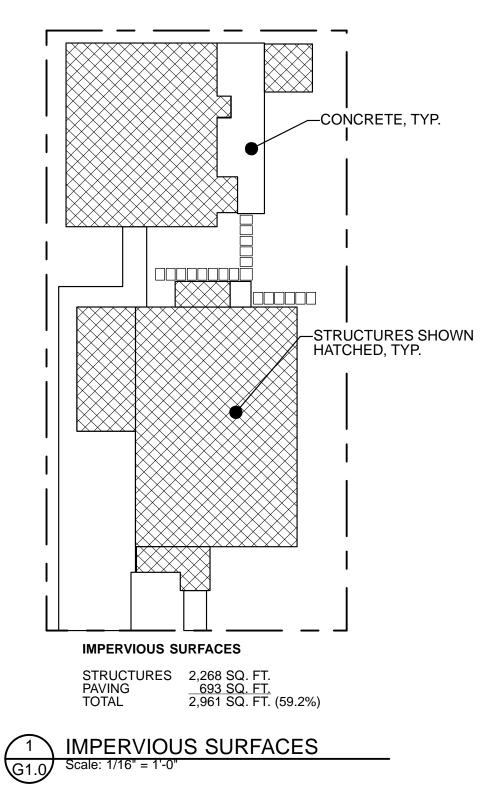

625 EVELYN AVENUE - REAR



RISER

ROOM

THICK

WEST WITH

HARTIGAN ARCHITECTURE

MICHAEL HARTIGAN, AIA ARCHITECT

1528 VERSAILLES AVENUE ALAMEDA, CA 94501 510•865•4213

Consultants

LEUNG TRUONG RESIDENCE **ADDITION**


625 EVELYN AVENUE ALBANY, CA 94706



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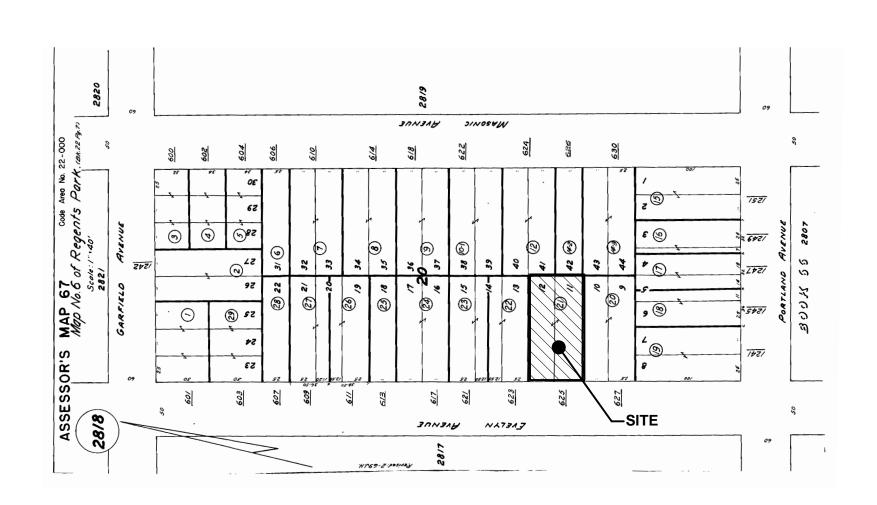
JOB:	20185	DATE:	9/1/2021		
SCALE	E: As Noted				
No.	Description		Date		
	DESIGN REVIEW		7/16/2024		
	DESIGN REVIEW	CMTS	11/16/2024		
	DESIGN REVIEW	REV	1/6/2025		
	DESIGN REVIEW	REV	3/3/2025		
	DESIGN REVIEW	REV	3/28/2025		
SHEE	SHEET TITLE:				
SYN	NERAL NOTES MBOLS BREVIATIONS	6			
SHEE		31	.0		




621 EVELYN AVENUE

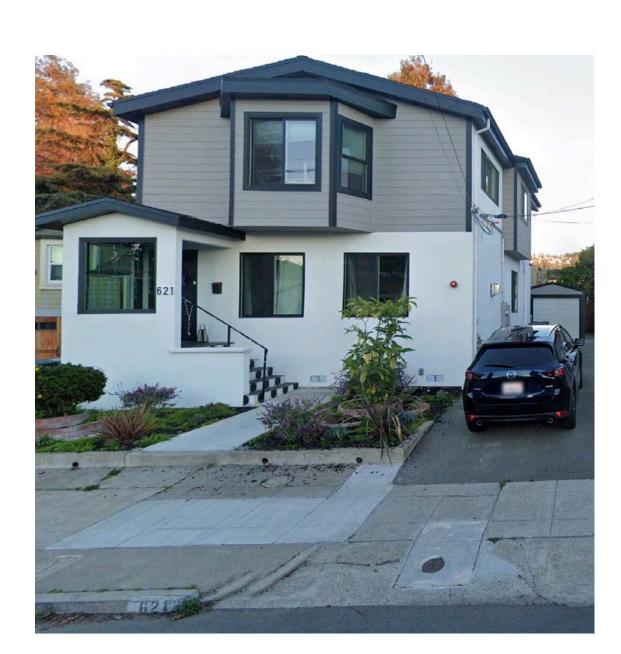


3 NEIGHBORHOOD PHOTOS





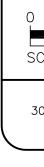

ASSESSOR'S MAP (1)C1.0 NTS

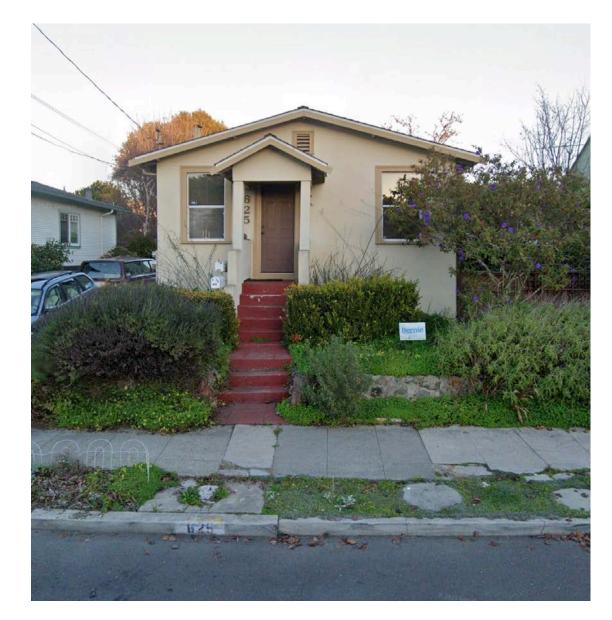





623 EVELYN AVENUE

SUBJECT PROPERTY

625 EVELYN AVENUE

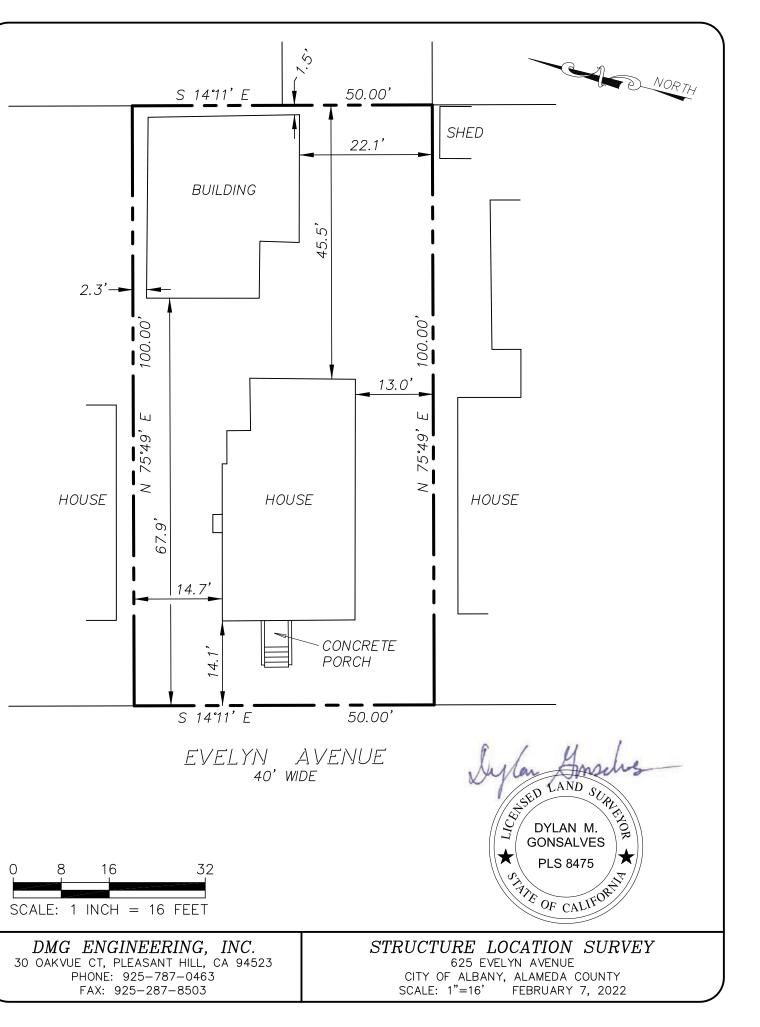

2 SURVEY

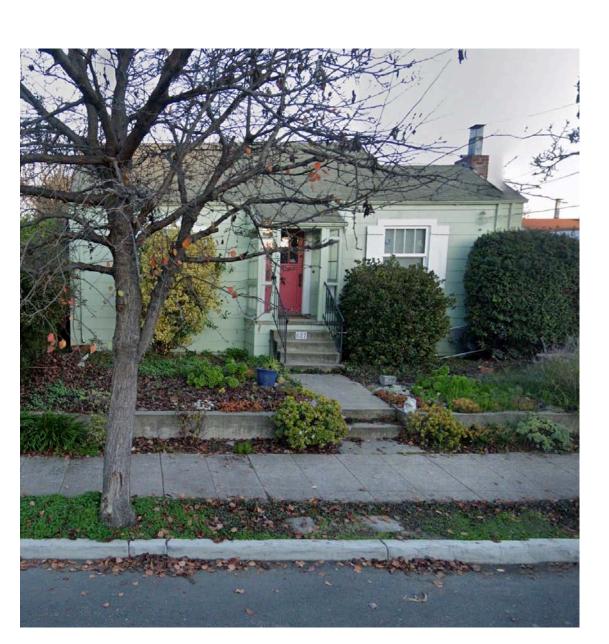

627 EVELYN AVENUE



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LEUNG TRUONG RESIDENCE ADDITION


625 EVELYN AVENUE ALBANY, CA 94706





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	DESIGN REVIEW	REV	1/6/2025
	DESIGN REVIEW	REV	3/3/2025
	DESIGN REVIEW	REV	3/28/2025
SHEET TITLE:			
SITE SURVEY ASSESSOR'S MAP PHOTOS			
SHEET NUMBER: C1.0			





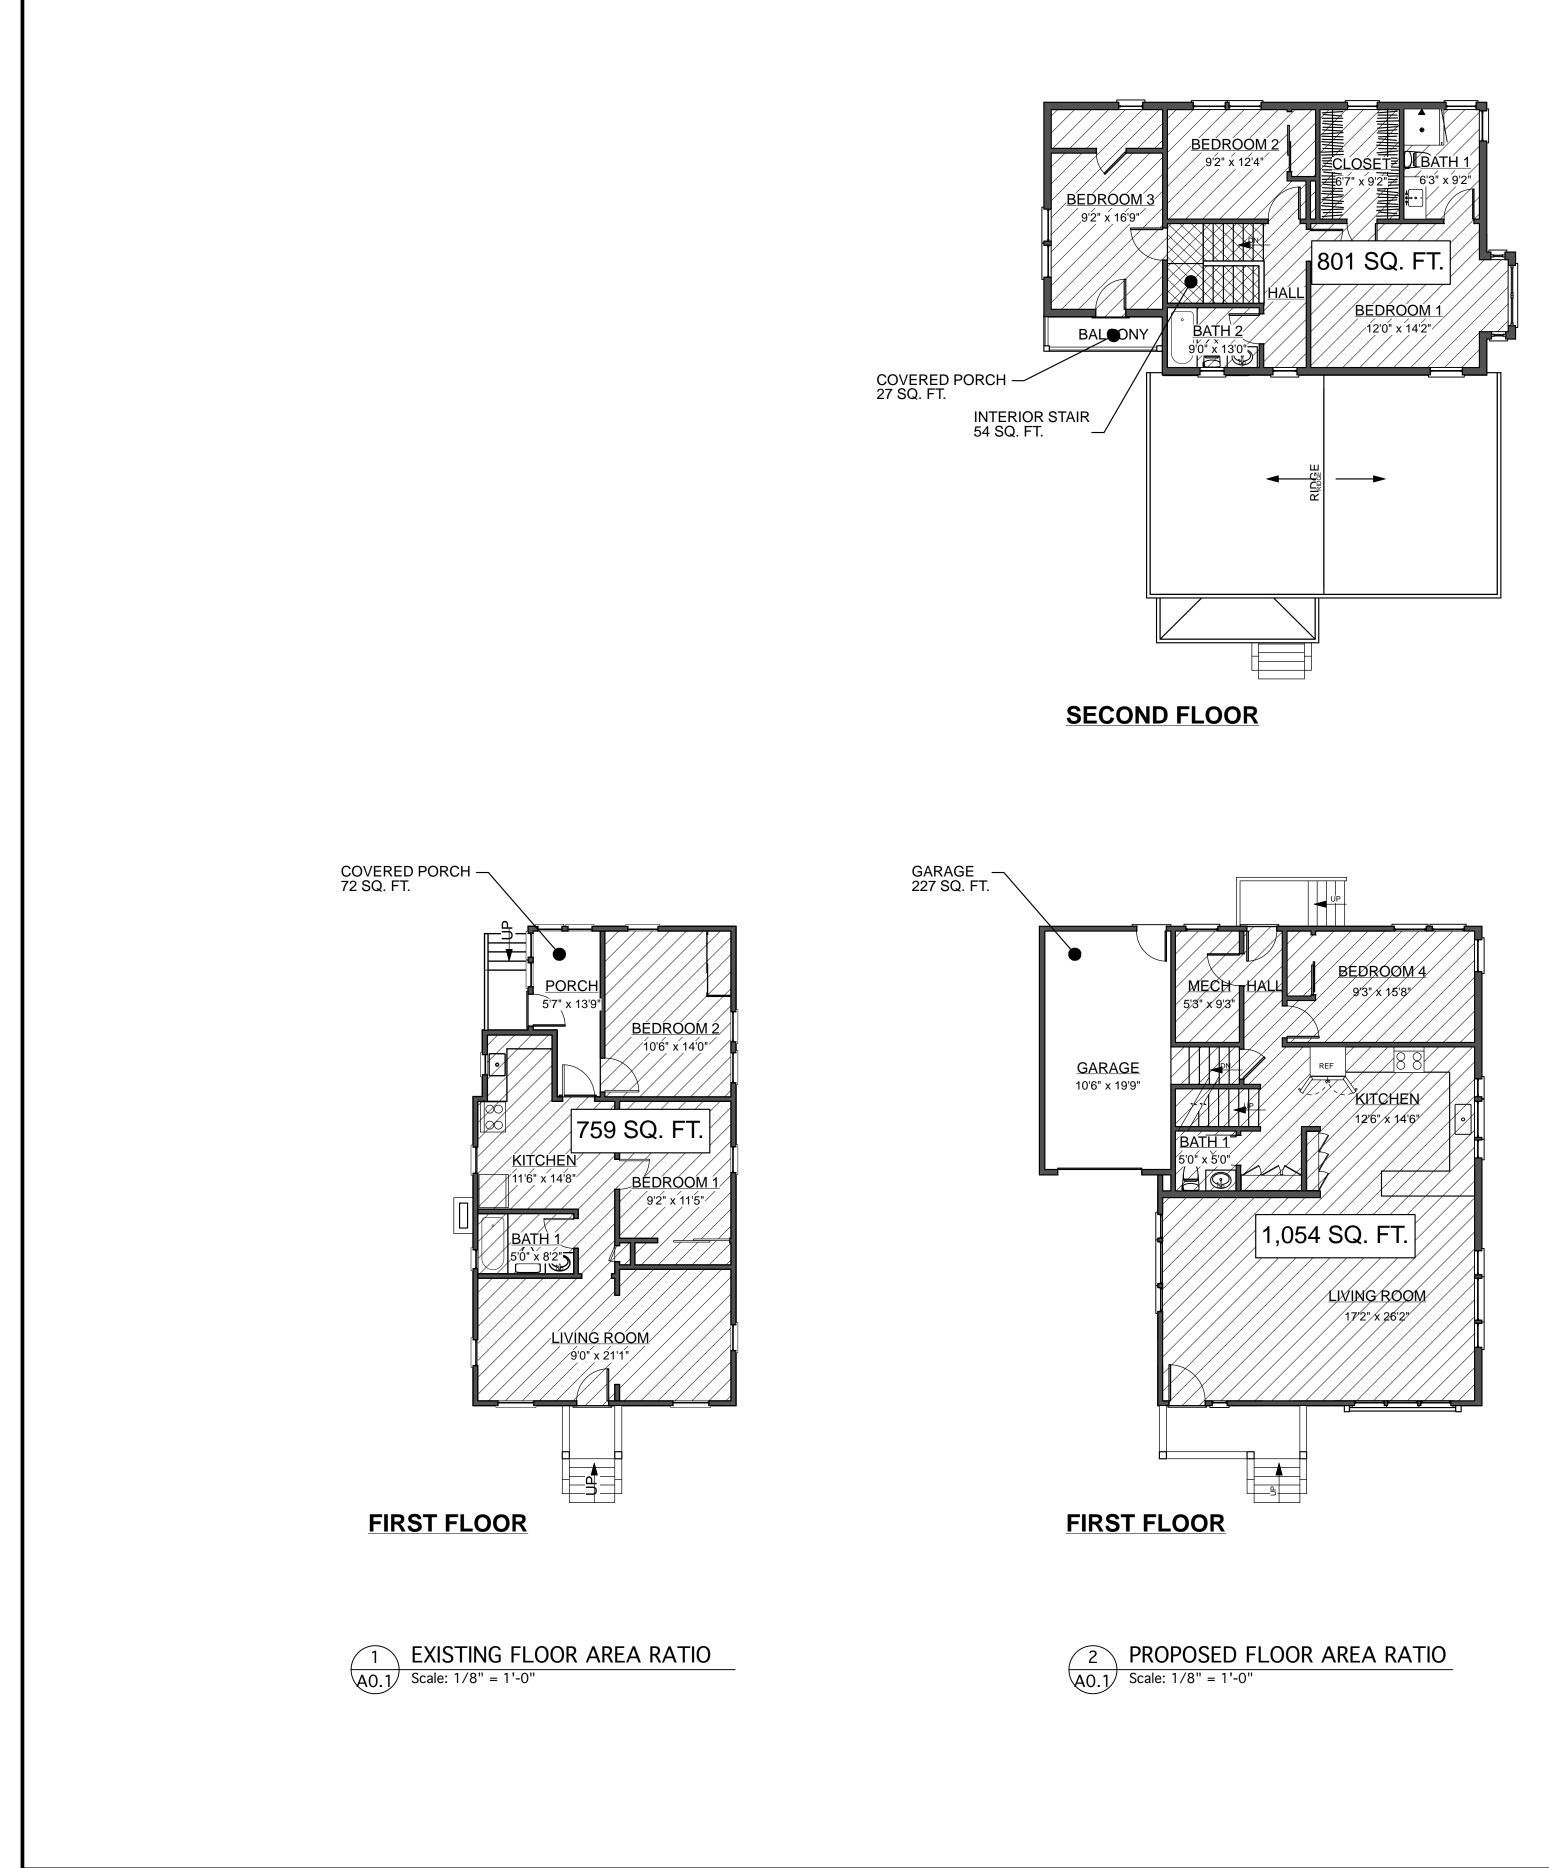

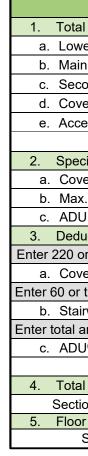

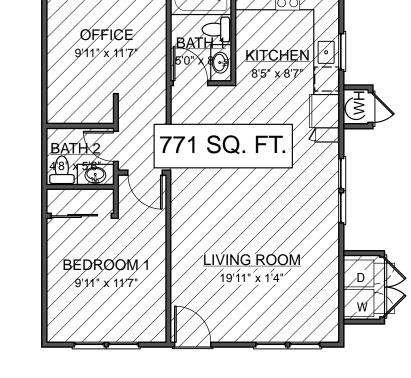FLOOR AREA RATIO

	Existing	Proposed	Requirement		
al Floor Area (sq. ft.) ⁽²⁾					
wer Level/Basement ⁽³⁾	0	0			
ain Level	759	1,054			
cond floor	0	801			
vered Porch, Decks, Patios ⁽⁴⁾	72	27			
cessory Structure(s), incl. ADUs	836	836			
Total Area:	1,667	2,718			
ecific Floor Area (sq. ft.) included in	Section "1. Tot	al Floor Area" a	above		
overed Parking	0	227			
ax. Stairwell Footprint	0	54			
OU (not JADU)	771	771			
ductions (sq. ft.)					
or the number in column in 2.a., wh	ichever is less				
overed Parking	0	220			
r the number in column in 2.b., whic	hever is less				
airwell Footprint	0	54			
area of all ADUs in column in 2.c th	nat are 800 sq.	ft. or less, othe	rwise enter zero		
)U ⁽⁵⁾	771	771			
Total Deduction:	771	1,045			
al FAR square footage (sq. ft.)					
tion 1. total minus Section 3. total:	896	1,673	max. sq. ft.		
or Area Ration (FAR)					
Section 4 total divided by lot size:	17.9%	33.4%	55% max.		



EXISTING ACCESSORY STRUCTURE 3 A0.1 Scale: 1/8" = 1'-0"

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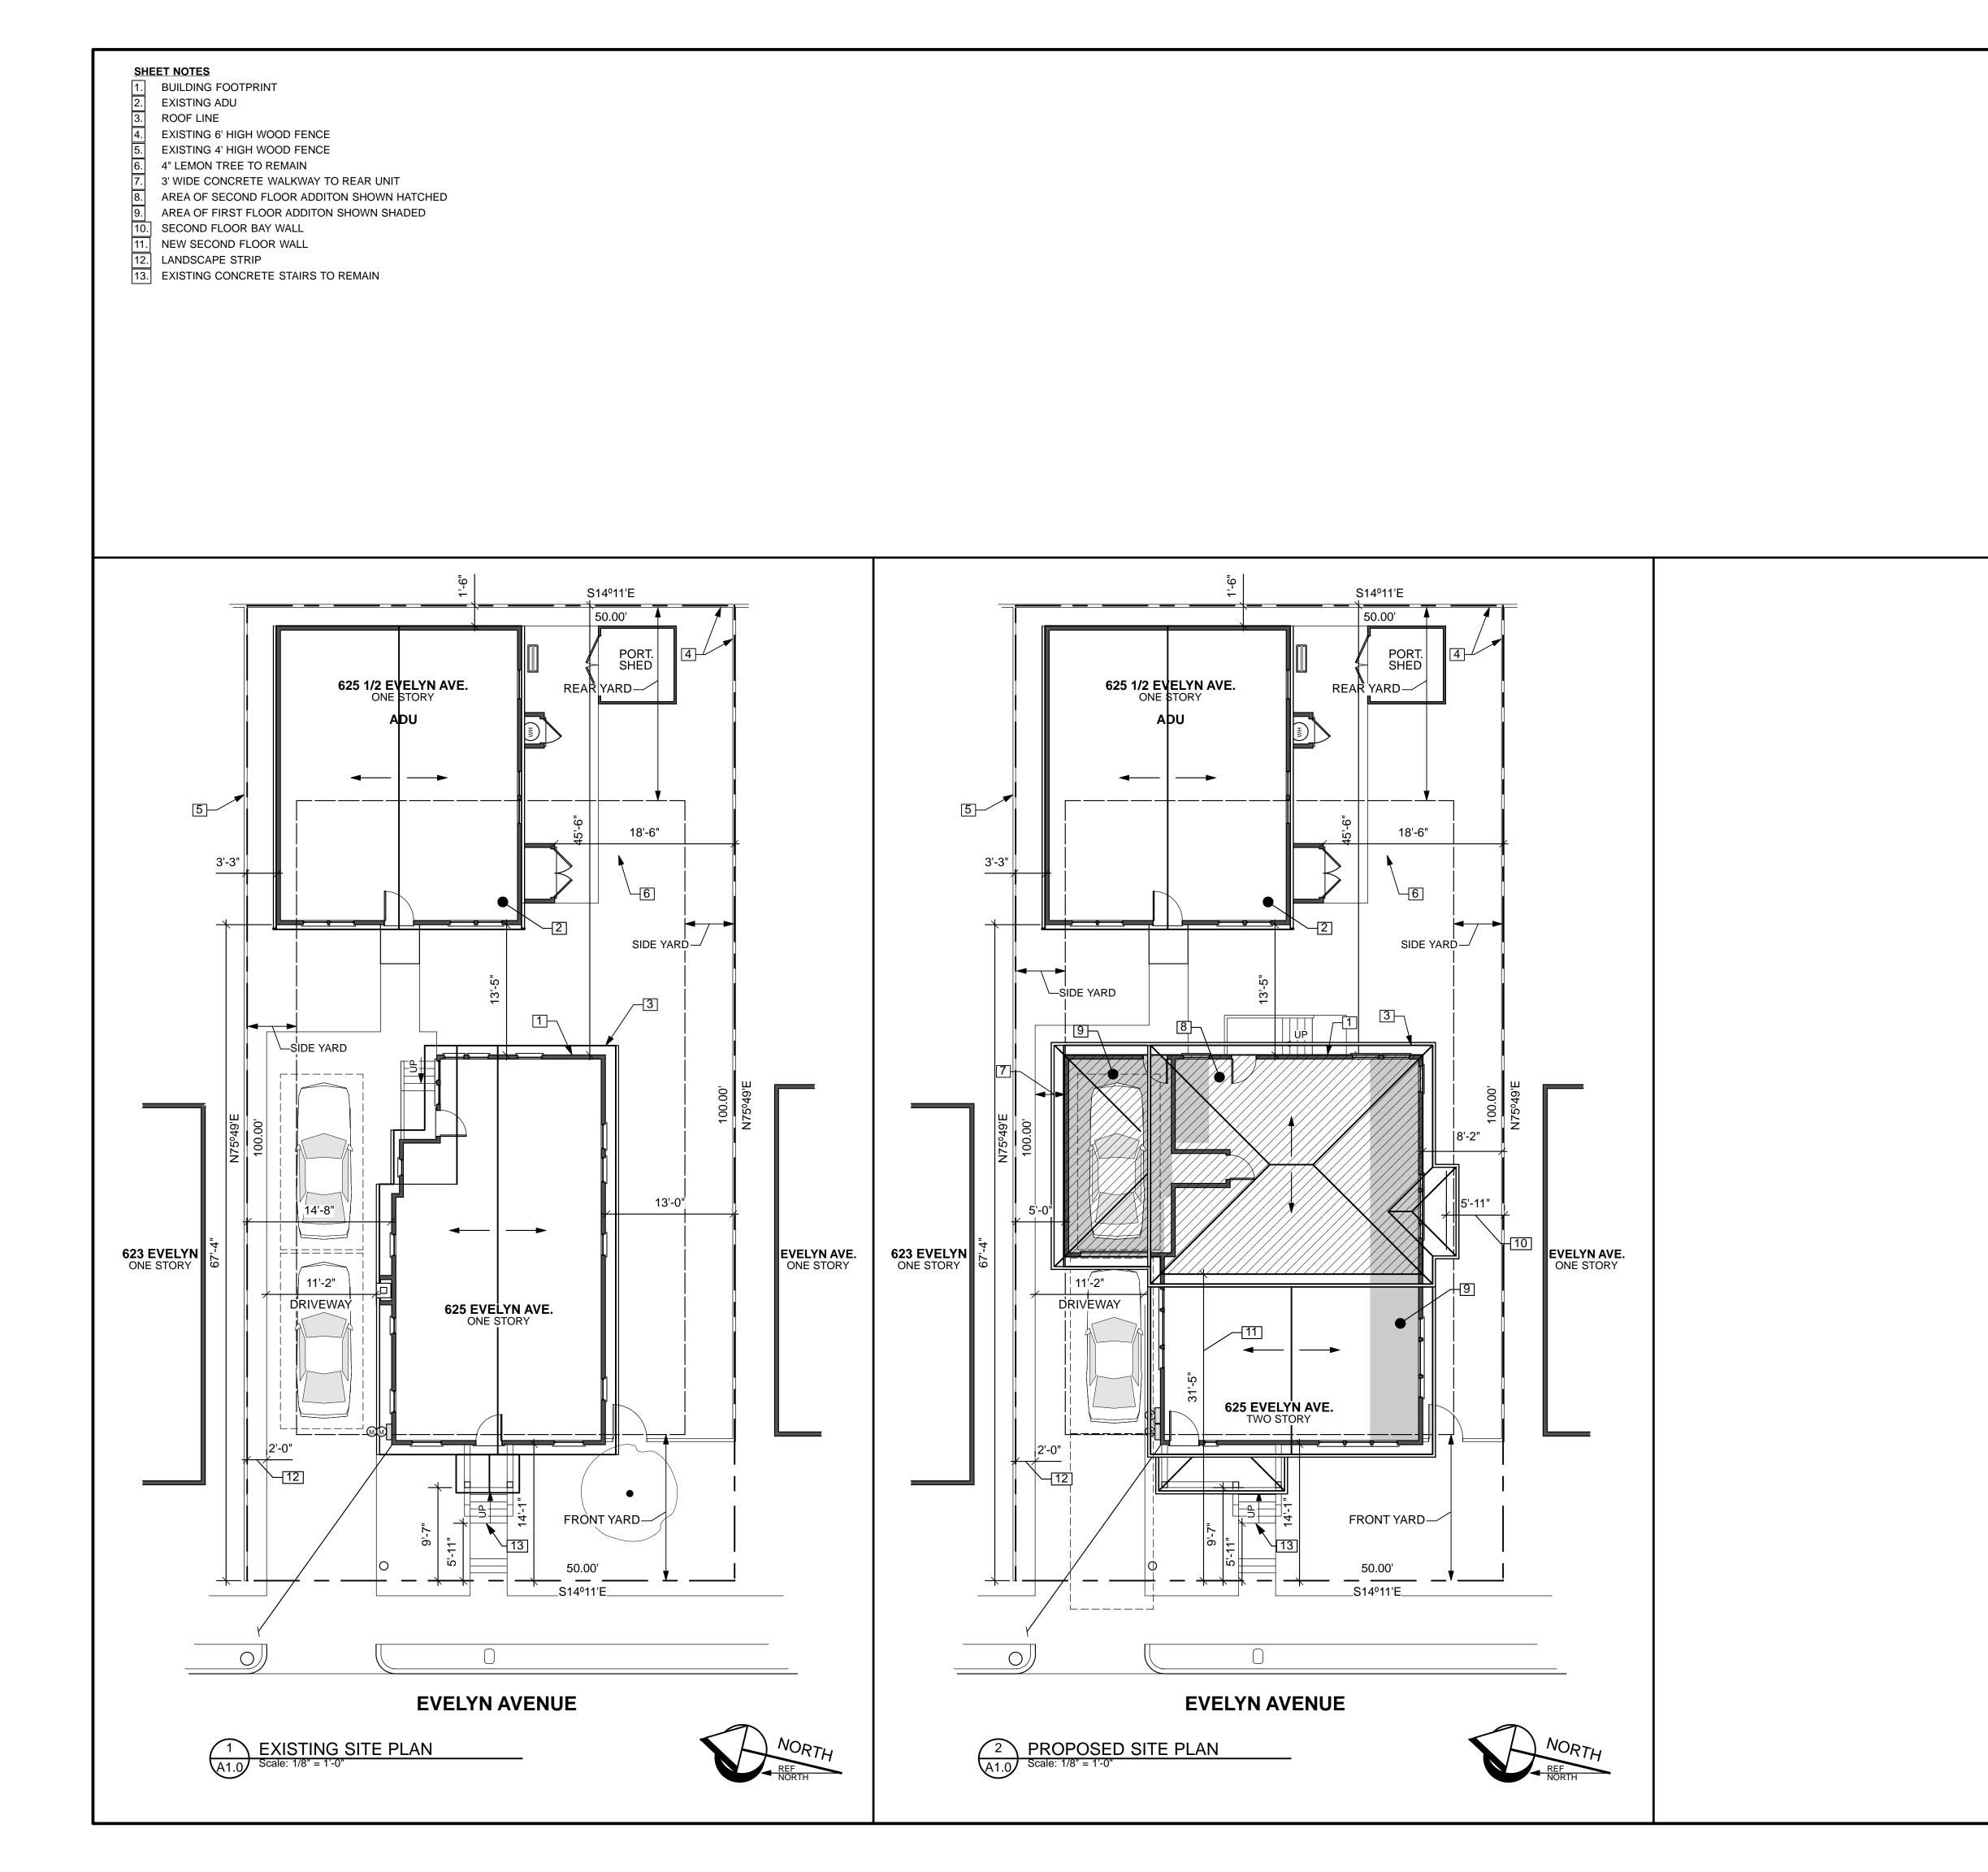


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	DESIGN REVIEW REV	1/6/2025		
	DESIGN REVIEW REV	3/3/2025		
	DESIGN REVIEW REV	3/28/2025		
SHEE	SHEET TITLE:			
FLOOR AREA RATIO				





HARTIGAN RCHITECTURE

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LEUNG TRUONG RESIDENCE ADDITION

625 EVELYN AVENUE ALBANY, CA 94706





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	DESIGN REVIEW REV	1/6/2025	
	DESIGN REVIEW REV	3/3/2025	
	DESIGN REVIEW REV	3/28/2025	
SHEET TITLE:			
EXISTING SITE PLAN			







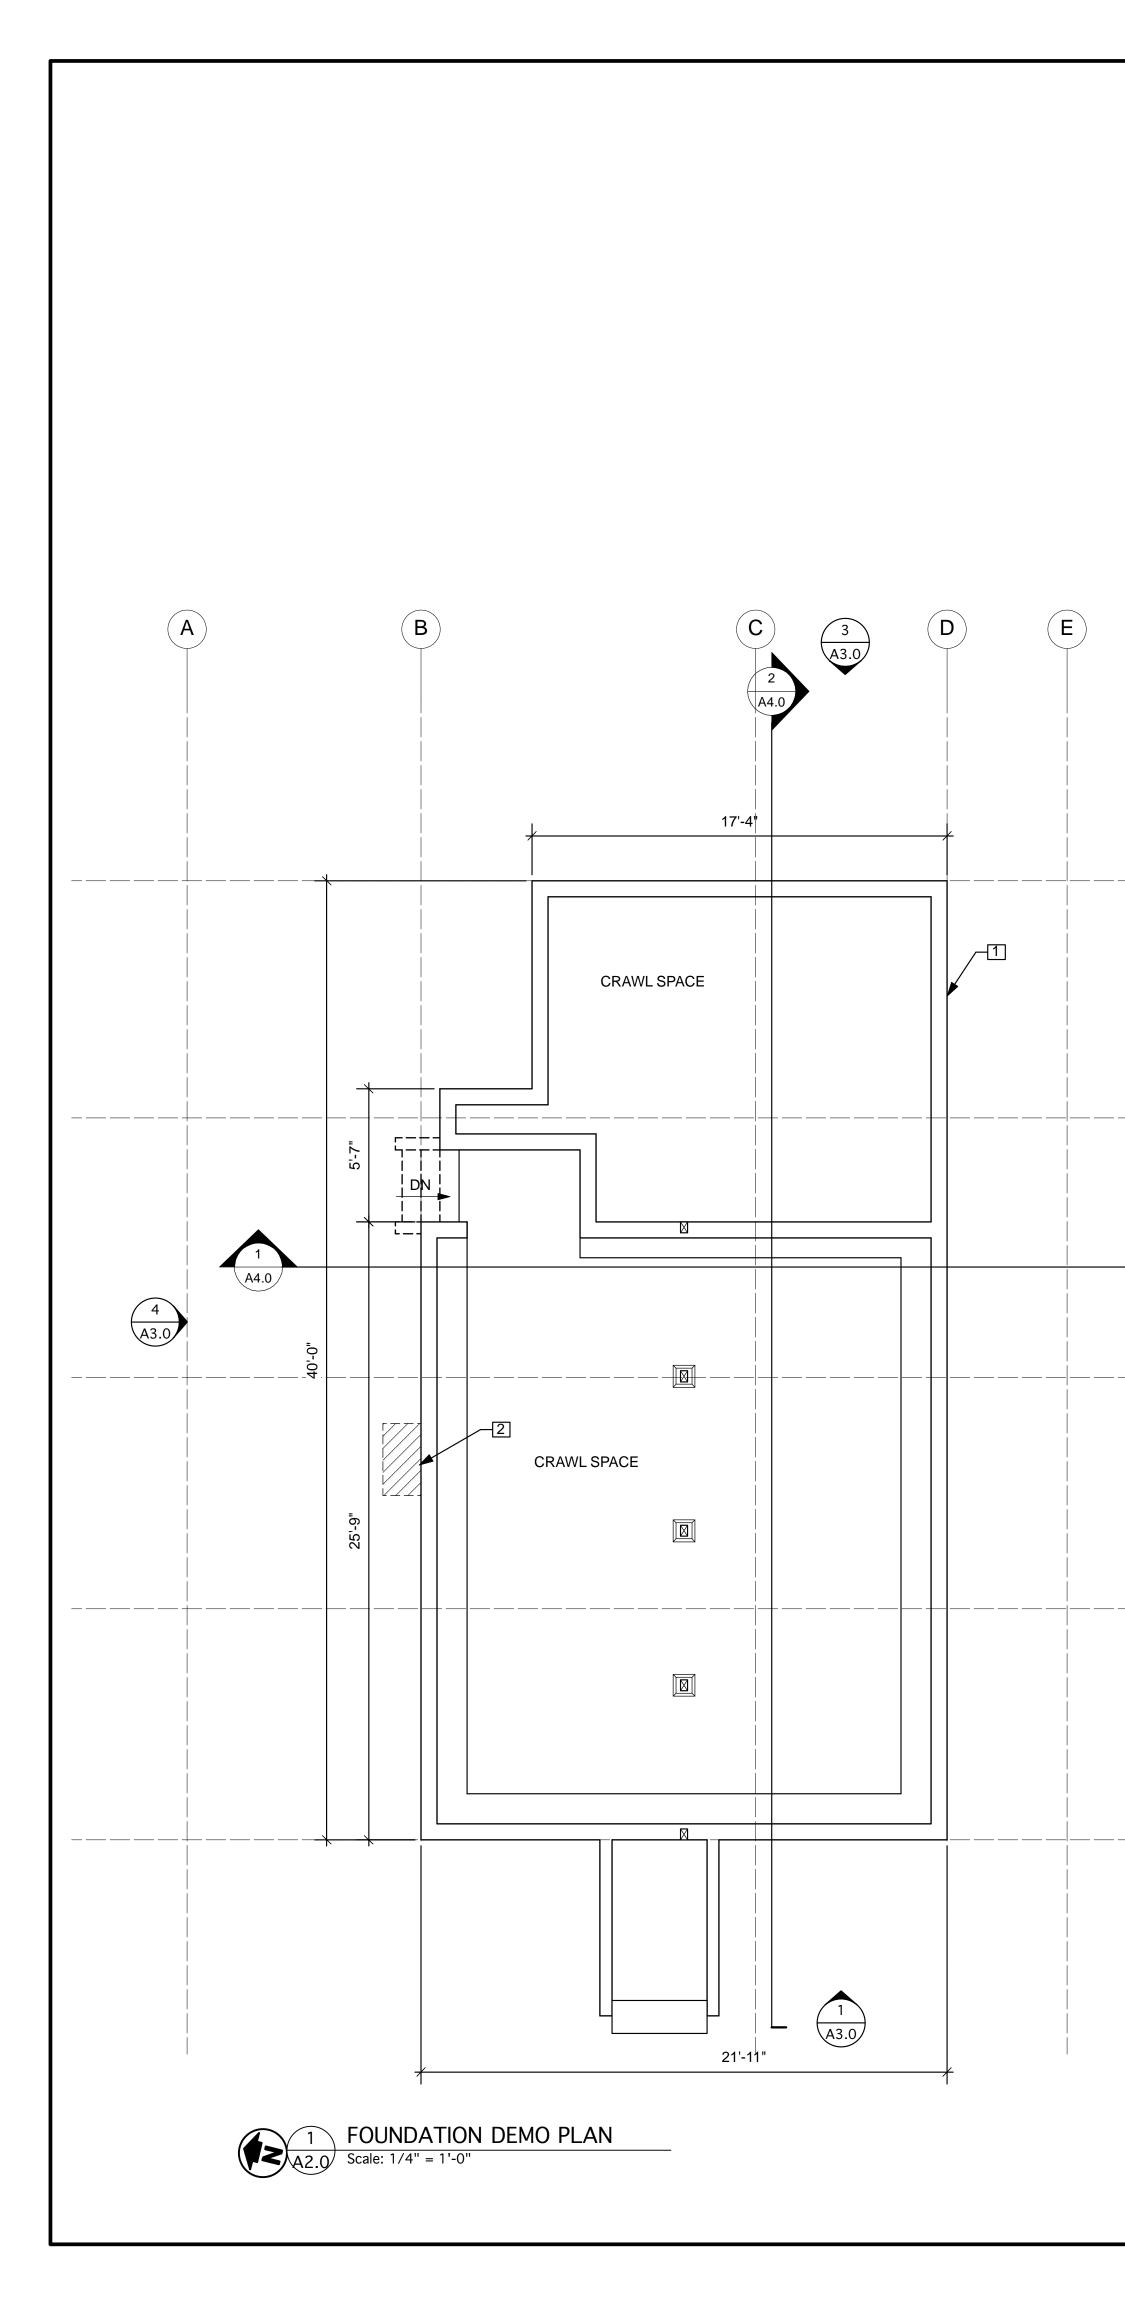

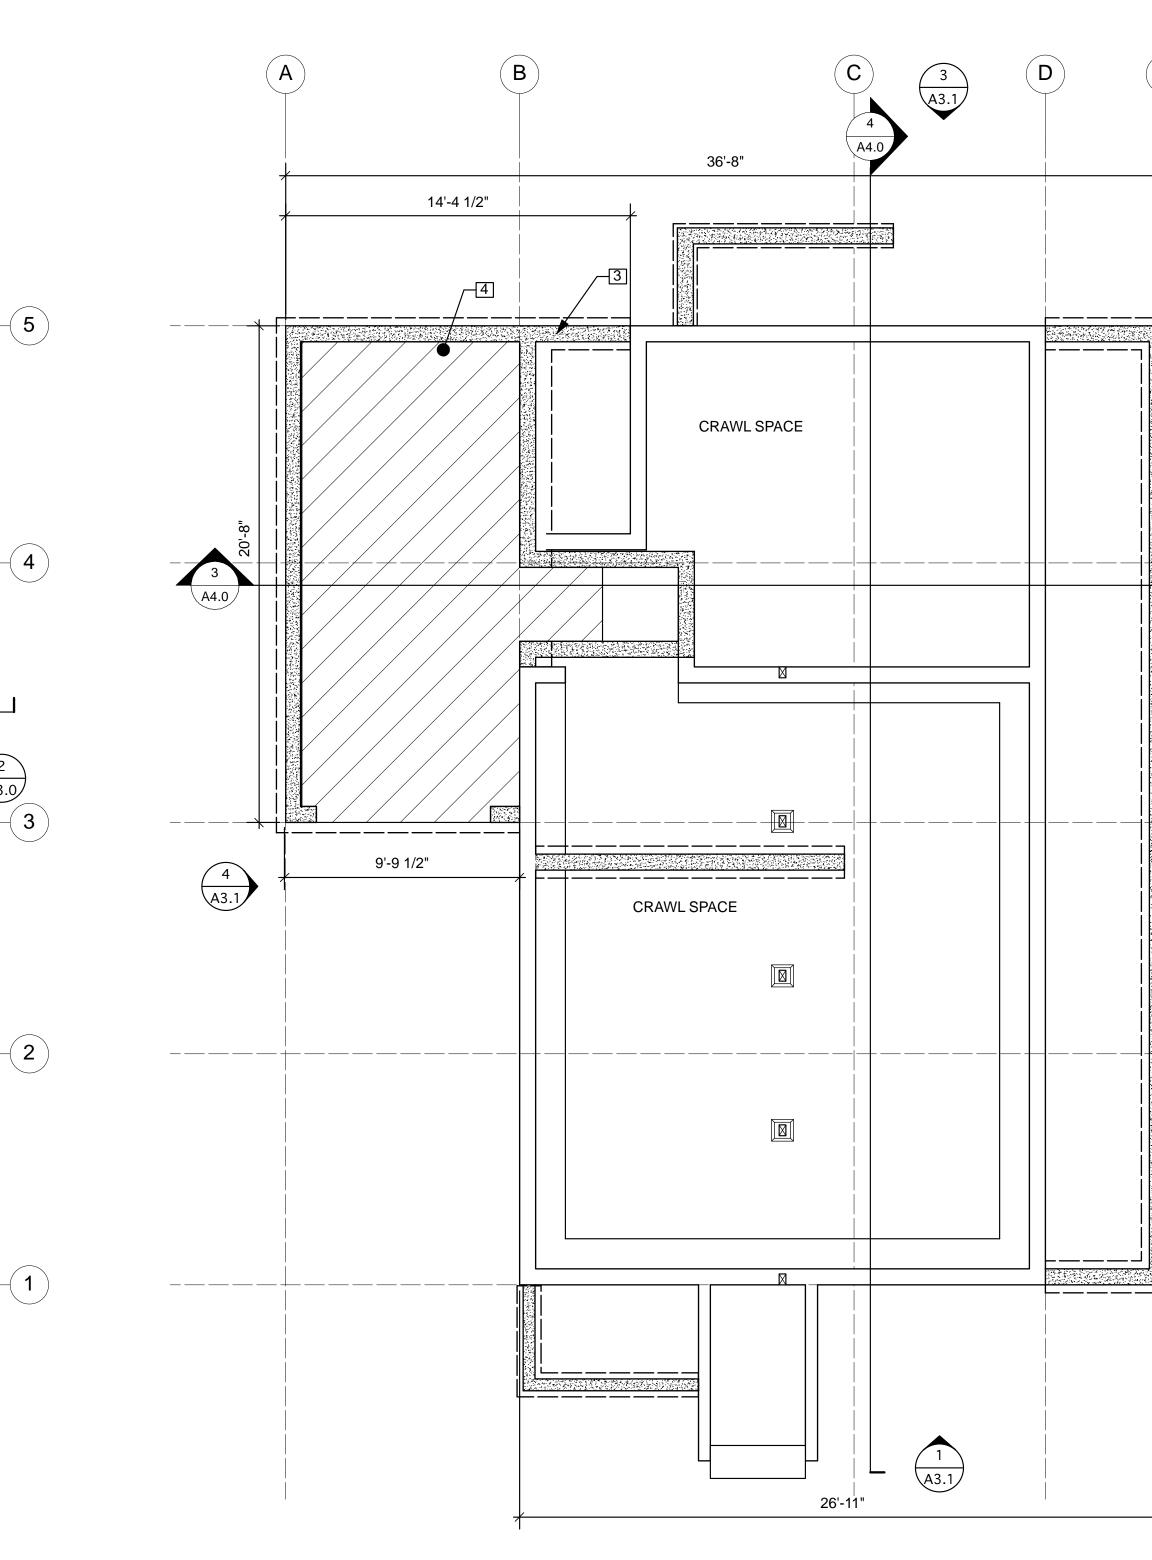(2) (A3.0)

SHEET NOTES

E

- 1. EXISTING FOUNDATION
- REMOVE BRICK CHIMNEY AND CONCRETE FOUNDATION SHOWN DASHED 2.
- 3. NEW FOUNDATION, TYP.

- 5

-(4

A3.1

3

-(2)

-(1)

4. NEW CONCRETE SLAB ON GRADE SHOWN HATCHED

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LEUNG TRUONG RESIDENCE ADDITION

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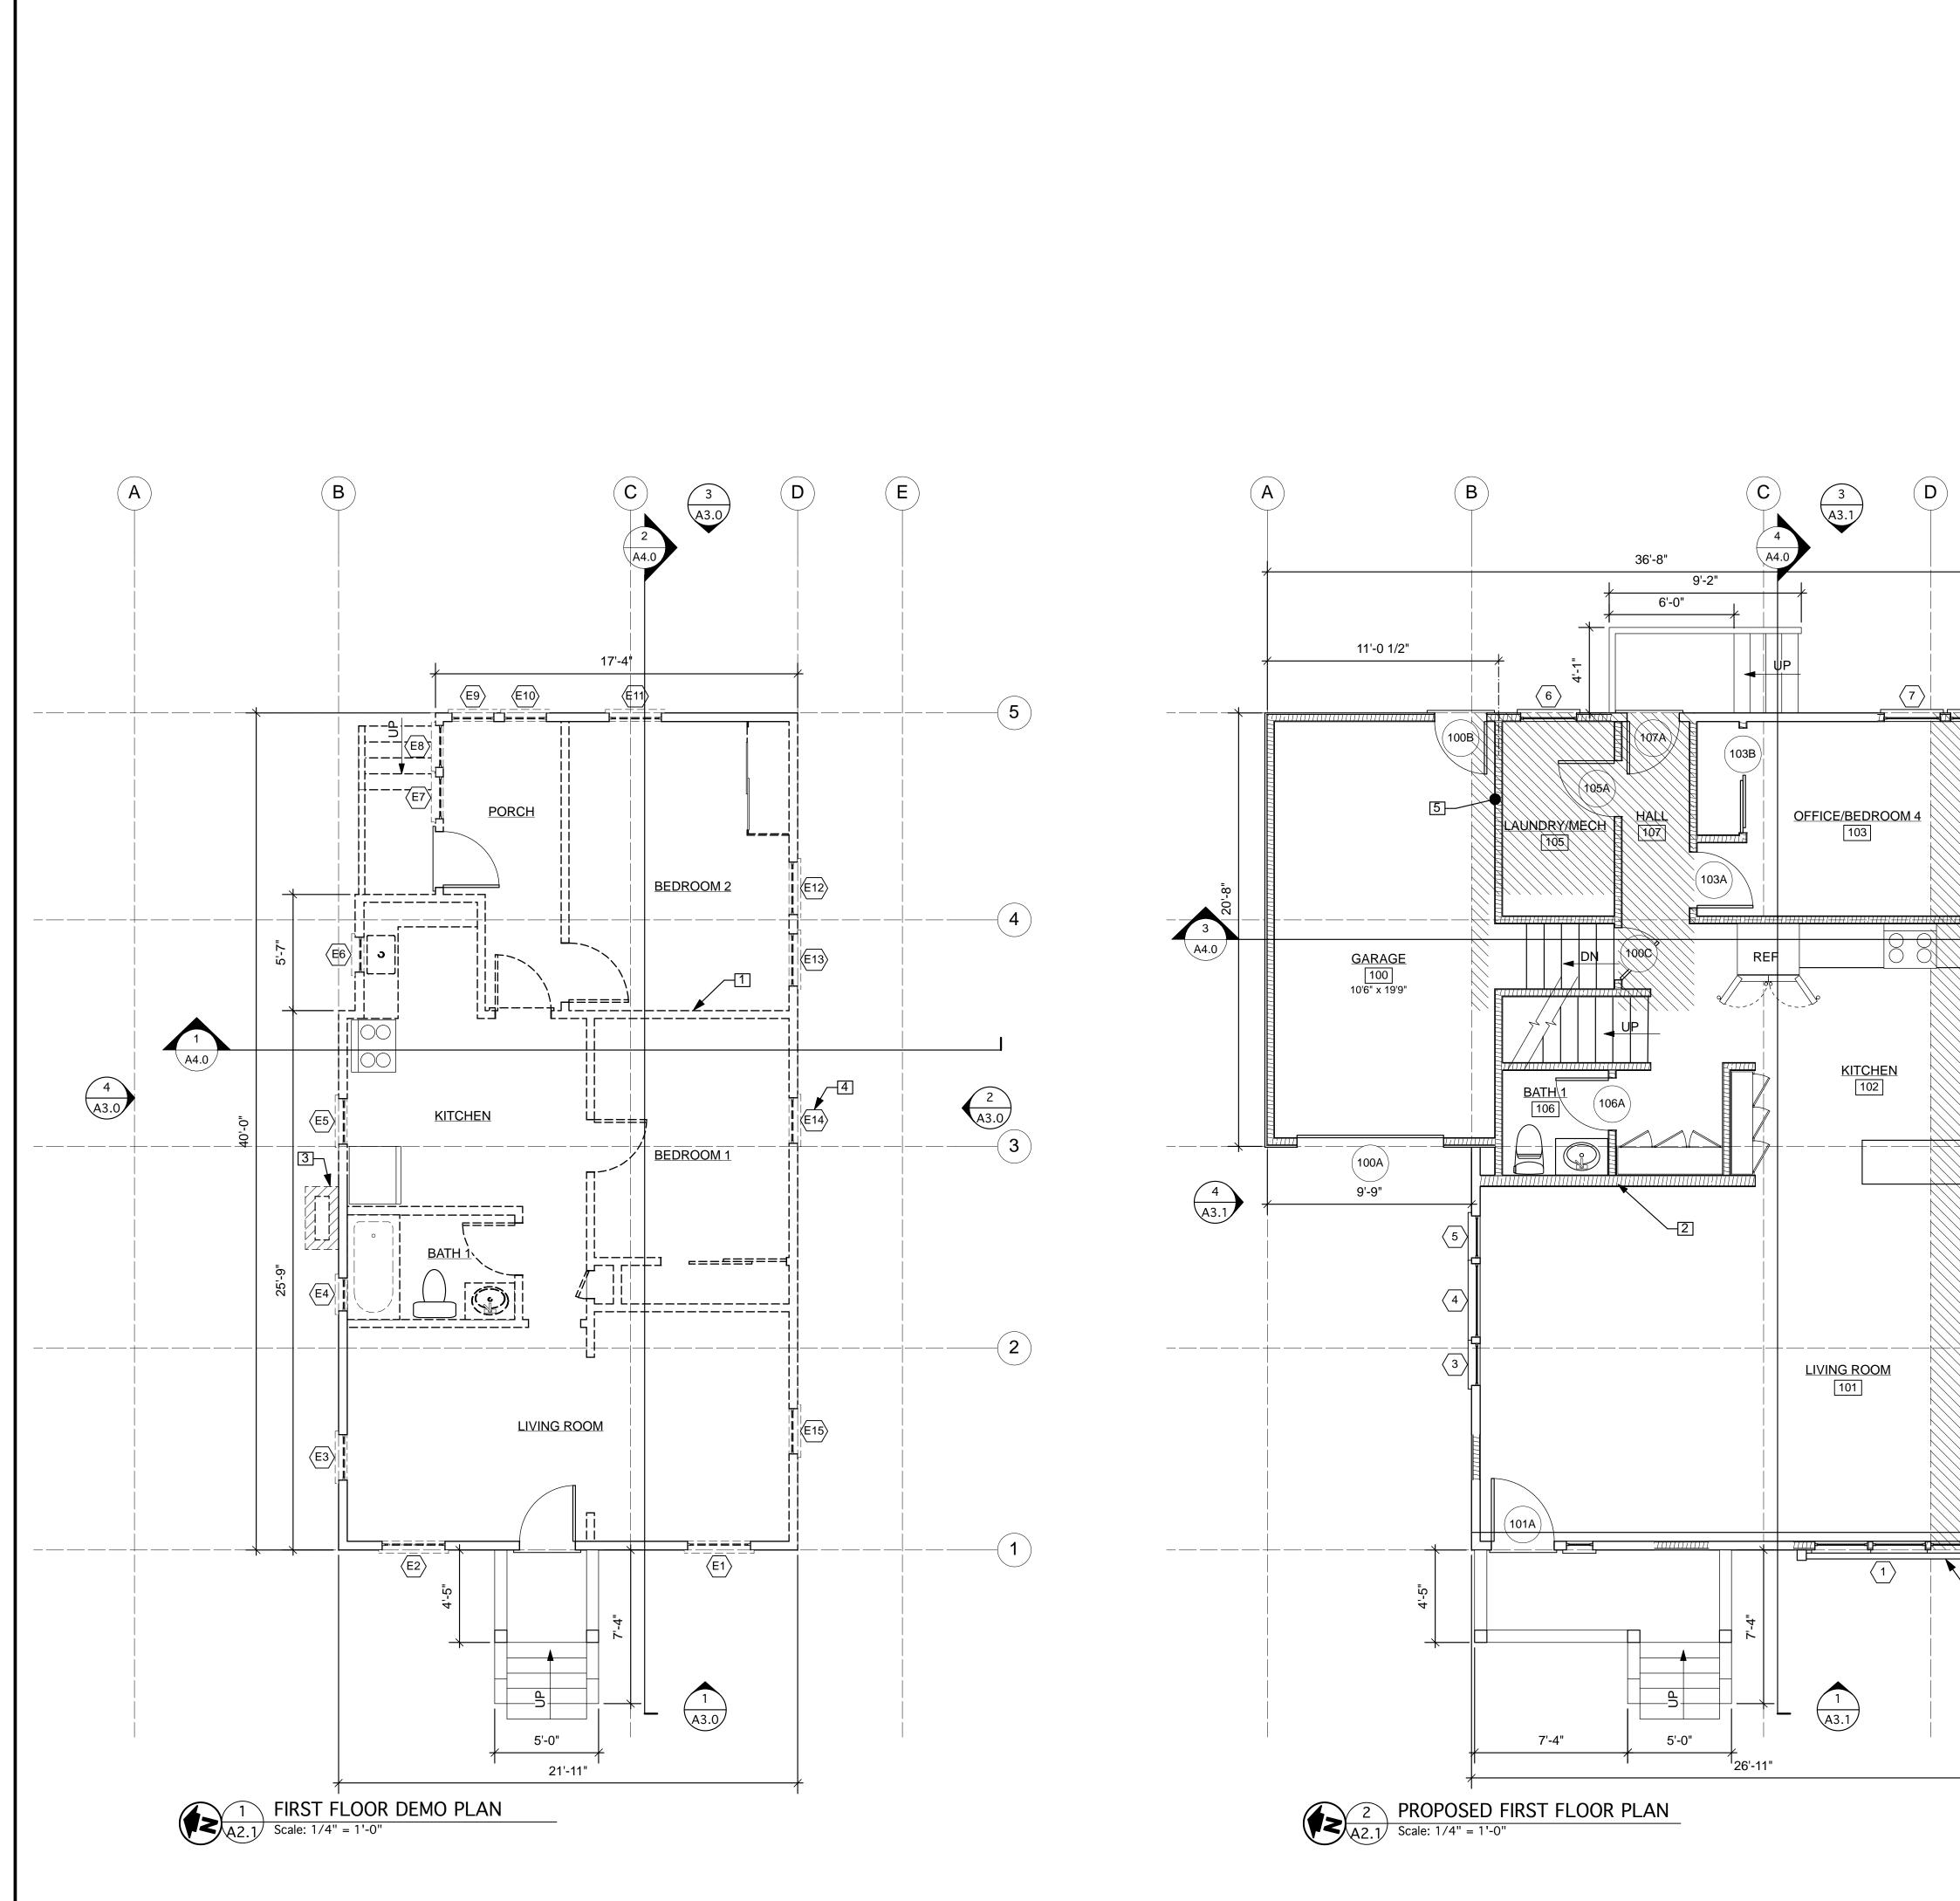


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	DESIGN REVIEW REV	1/6/2025
	DESIGN REVIEW REV	3/3/2025
	DESIGN REVIEW REV	3/28/2025
SHEE	T TITLE:	
	STING FOUNDATIC POSED FOUNDAT	
01155		

A2.0



SHEET NOTES

- WALLS AND MATERIALS TO BE REMOVED SHOWN DASHED, TYP. NEW WALLS SHOWN HATCHED, TYP.
- REMOVE EXISTING BRICK FIREPLACE AND CHIMNEY
- EXISTING WINDOWS SHOWN WITH PREFIX 'E', SEE SCHEDULE
- 116 SQ. FT. ADDITION SHOWN HATCHED
- 200 SQ. FT. ADDITION SHOWN HATCHED
- OVERHANG ABOVE, SHOWN DASHED


WOOD RAIL



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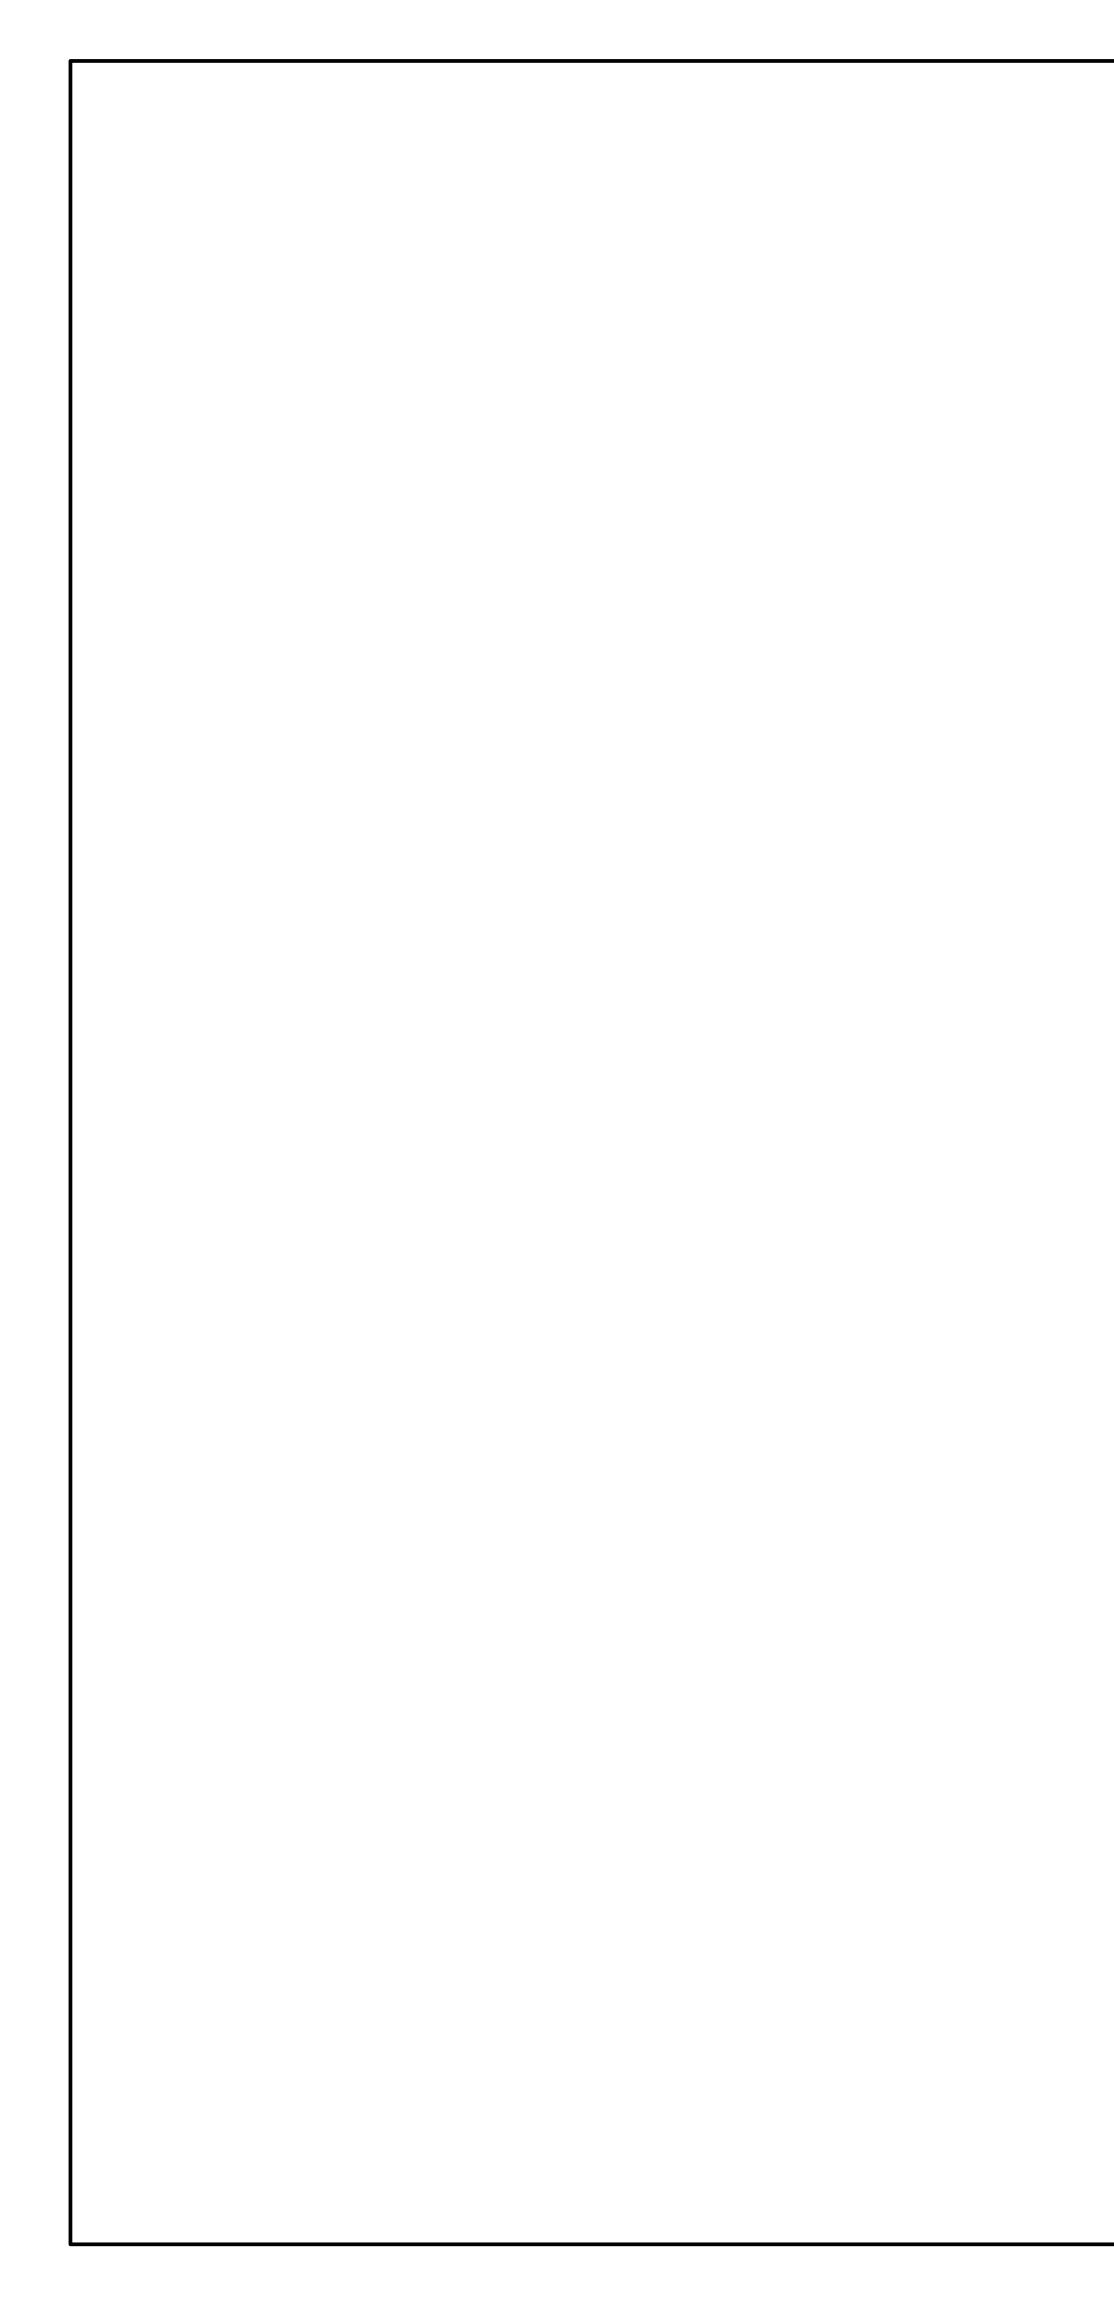
625 EVELYN AVENUE ALBANY, CA 94706





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	DESIGN REVIEW REV	1/6/2025
	DESIGN REVIEW REV	3/3/2025
	DESIGN REVIEW REV	3/28/2025
HEE		
	STING FIRST FLOO POSED FIRST FLO	
HEE		

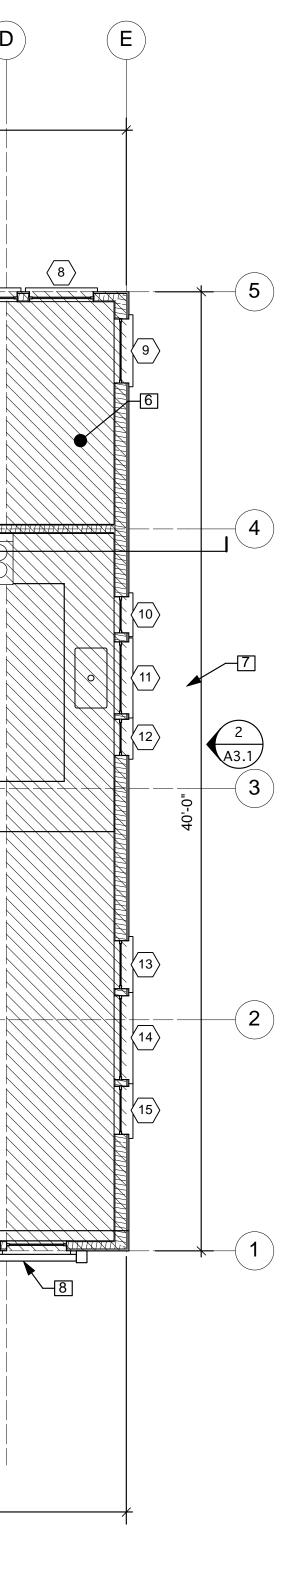



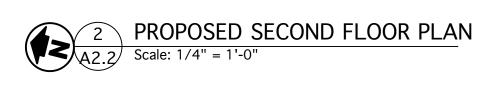

SHEET NOTES NEW WALLS SHOWN HATCHED, TYP.
 ROOF BELOW

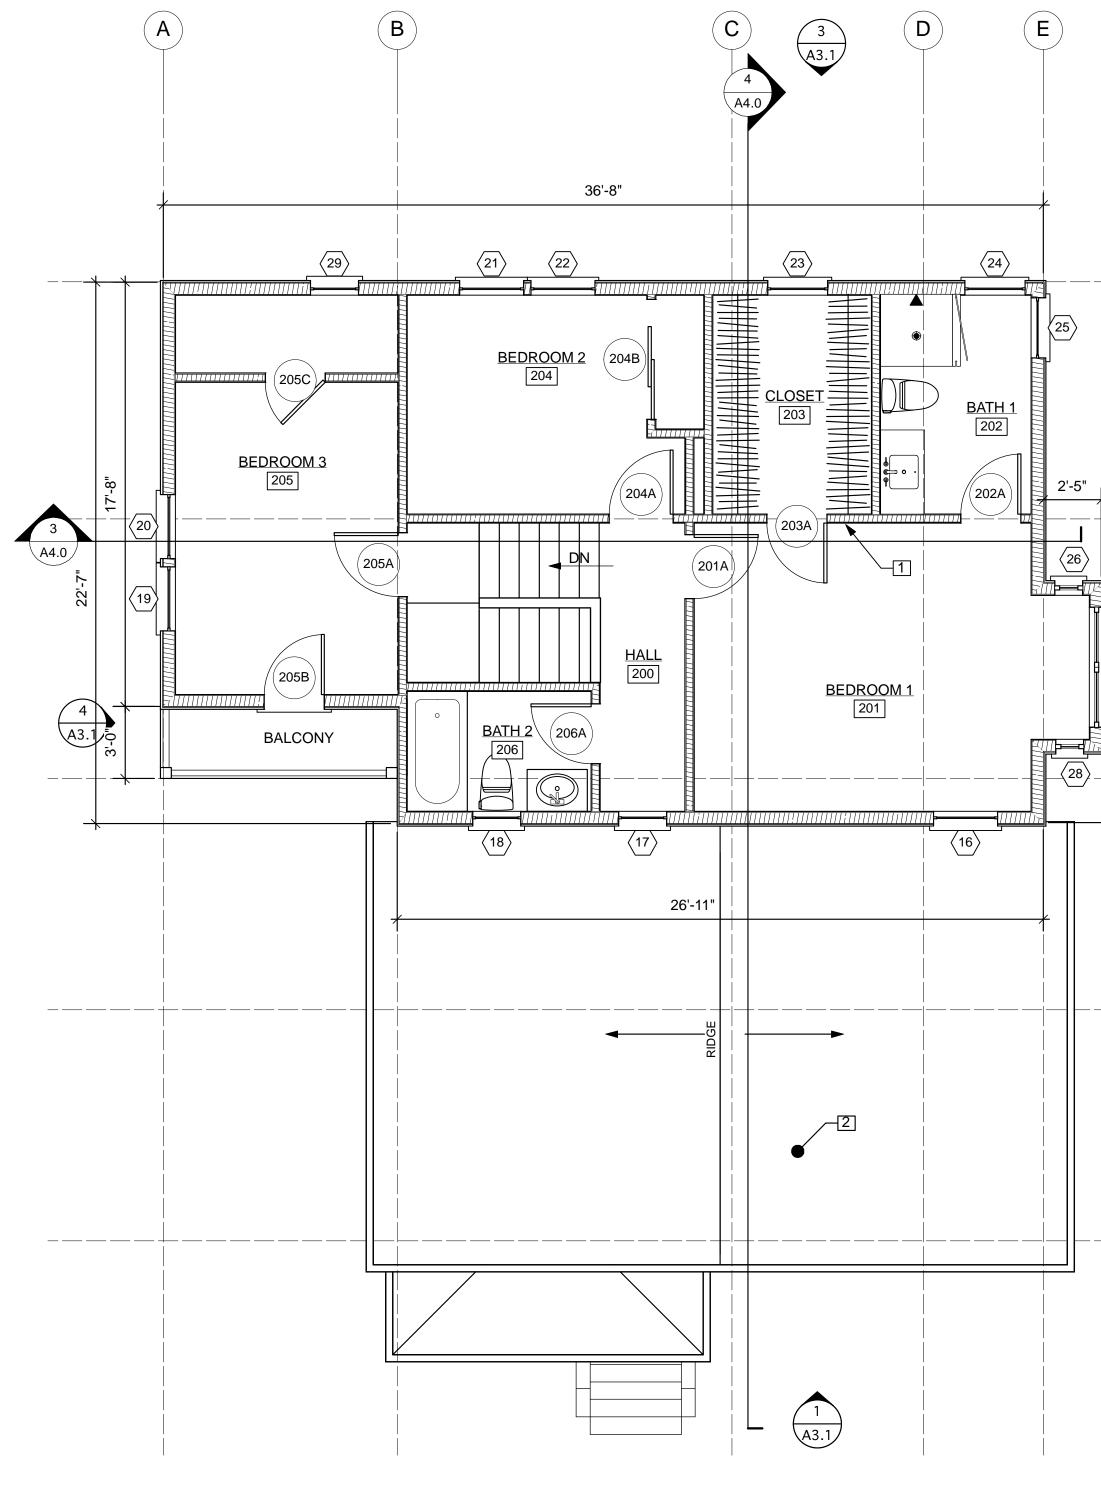- 5

4

 $\langle 27 \rangle$

2 A3.1

(3)

(2)

1

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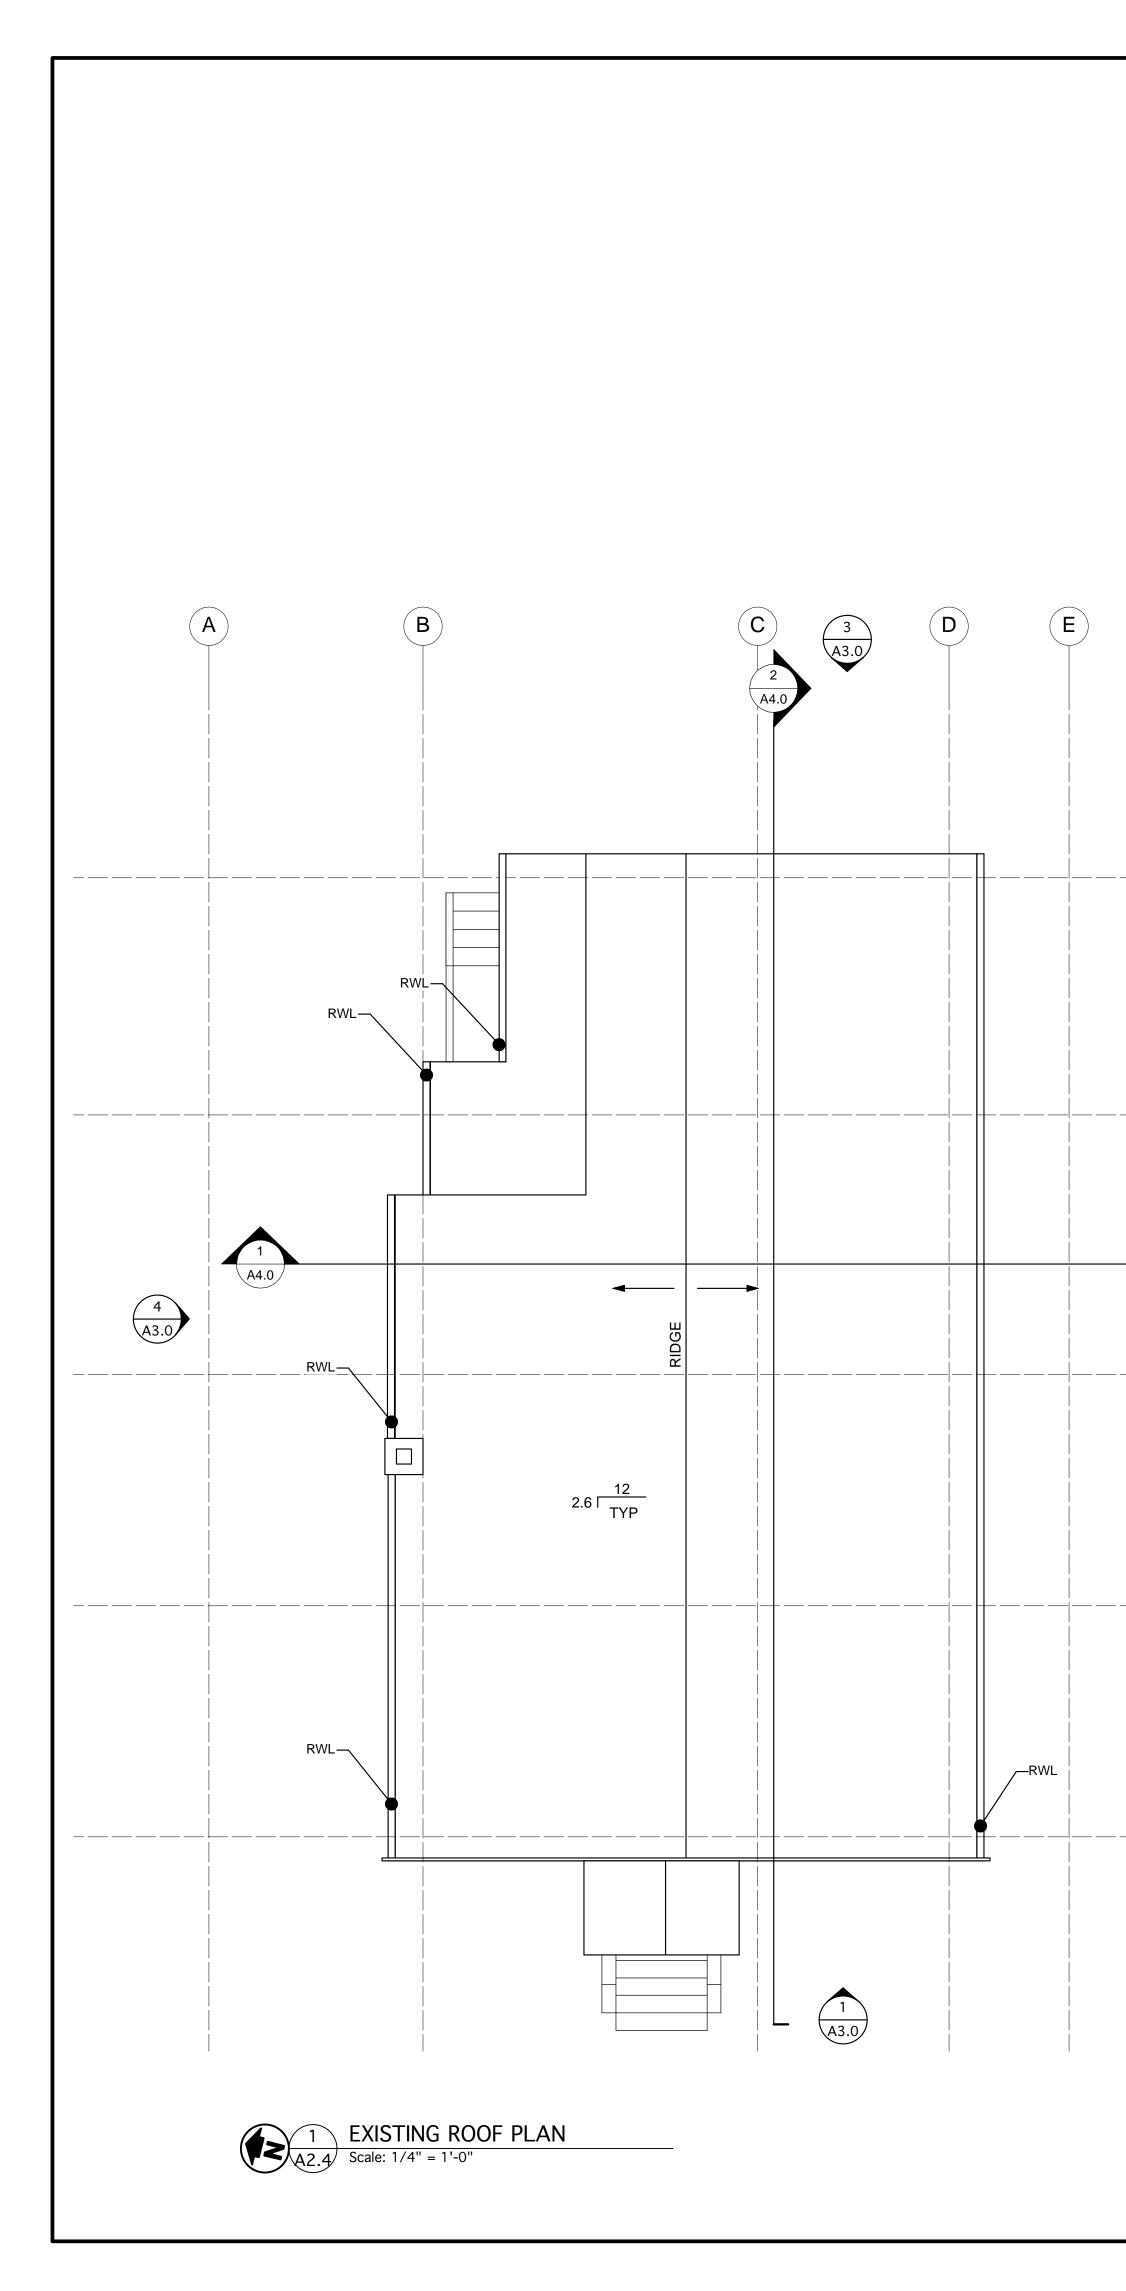
625 EVELYN AVENUE ALBANY, CA 94706




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No.	Description	Date		
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	DESIGN REVIEW CMT	S 11/16/2024		
	DESIGN REVIEW REV	1/6/2025		
	DESIGN REVIEW REV	3/3/2025		
	DESIGN REVIEW REV	3/28/2025		
SHEET TITLE:				
PROPOSED SECOND FLOOR PLAN				
SHEET NUMBER:				
	A	2.2		





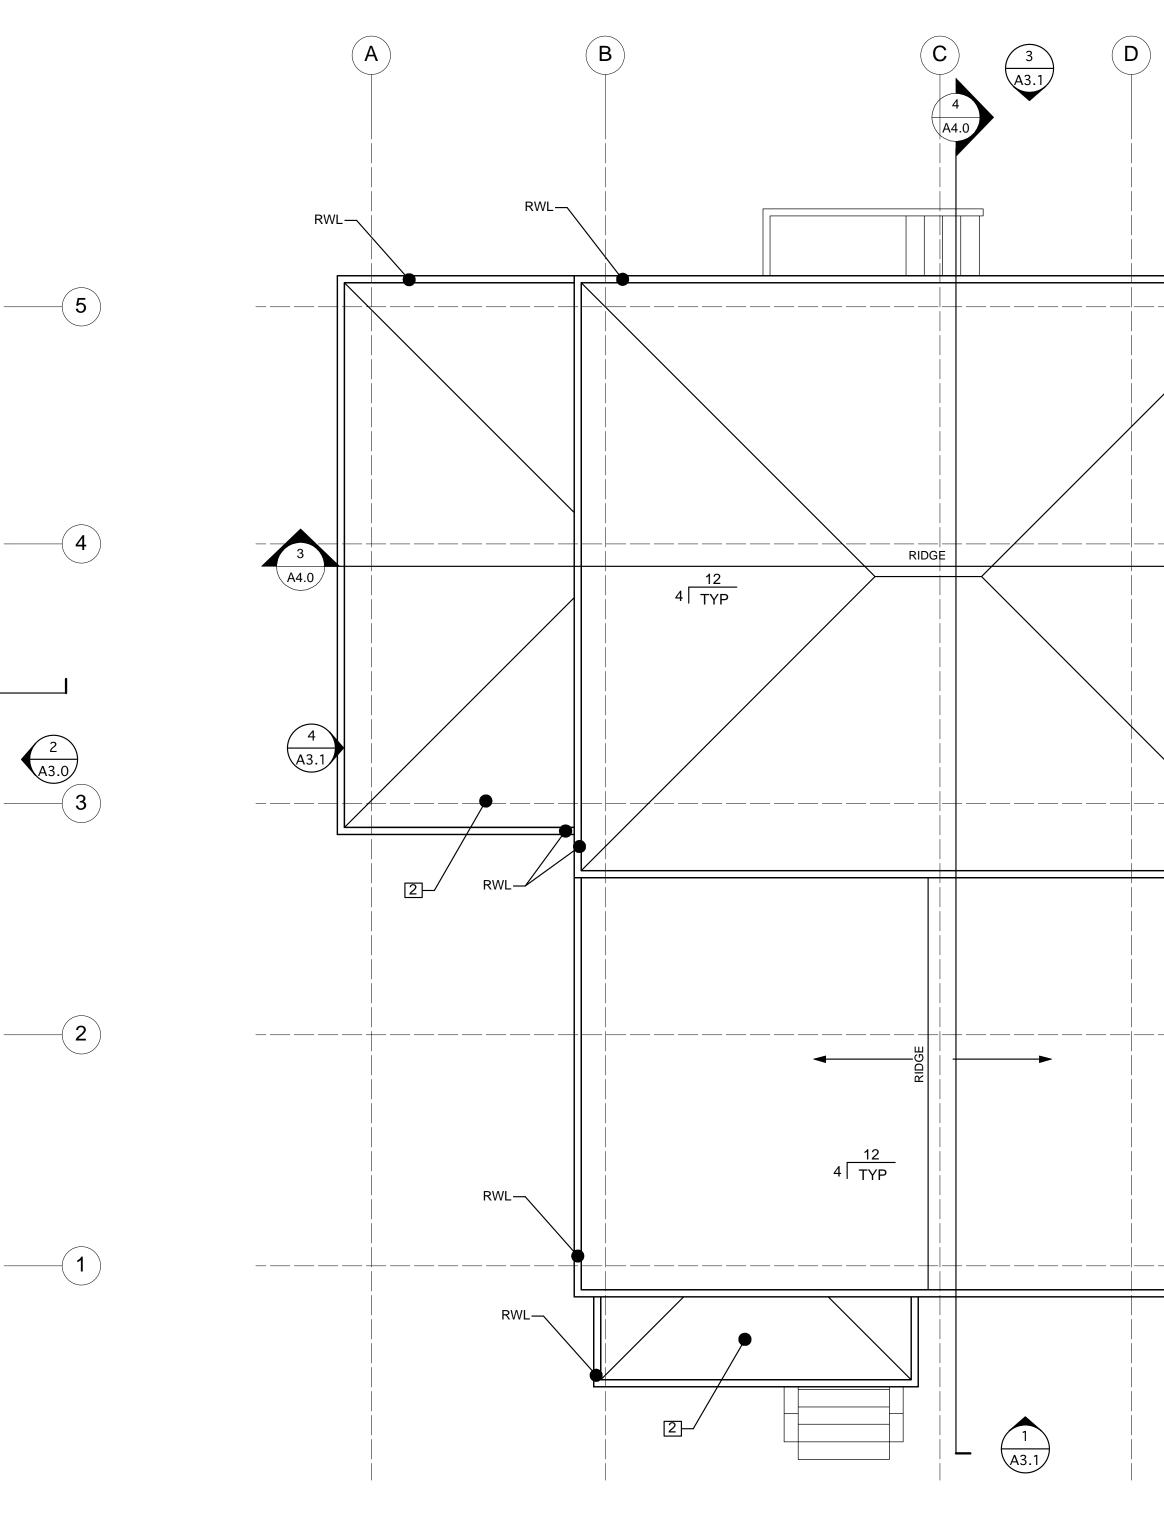

2 PROPOSED ROOF PLAN A2.4 Scale: 1/4" = 1'-0"

SHEET NOTES

1. NEW CLASS 'A' ASPHALT COMPOSITION SHINGLE ROOF, TYP.


2. LOWER ROOF




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LEUNG TRUONO RESIDENO ADDITIO	G CE
625 EVELYN AVE ALBANY, CA 94	
CONSED ARCHIER	fion
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JOB: 20185 DATE: SCALE: As Noted	9/1/2021
No.DescriptionDESIGN REVIEWDESIGN REVIEW CMTSDESIGN REVIEW REVDESIGN REVIEW REVDESIGN REVIEW REVDESIGN REVIEW REV	Date 7/16/2024 11/16/2025 1/6/2025 3/3/2025 3/28/2025
SHEET TITLE: EXISTING ROOF PLAN PROPOSED ROOF PLA	N
SHEET NUMBER:	.4



- EXISTING ASPHALT ROLL ROOFING, TYP.
- EXISTING WOOD SIDING, 4" EXPOSURE
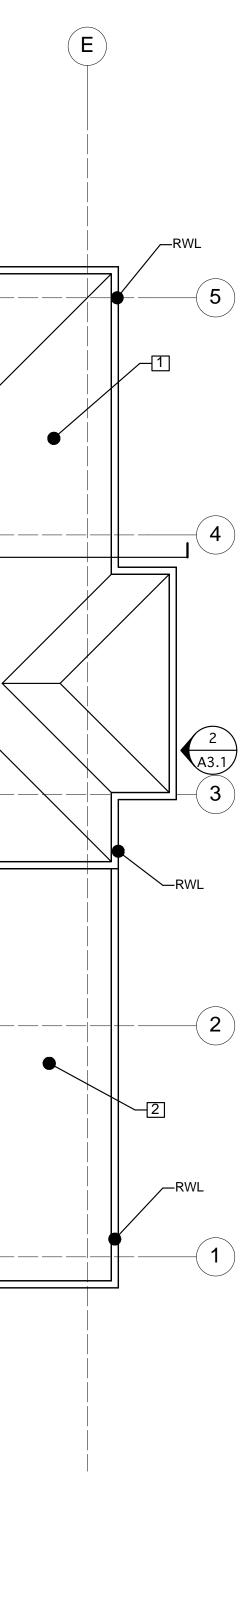
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LEUNG TRUONG RESIDENCE ADDITION

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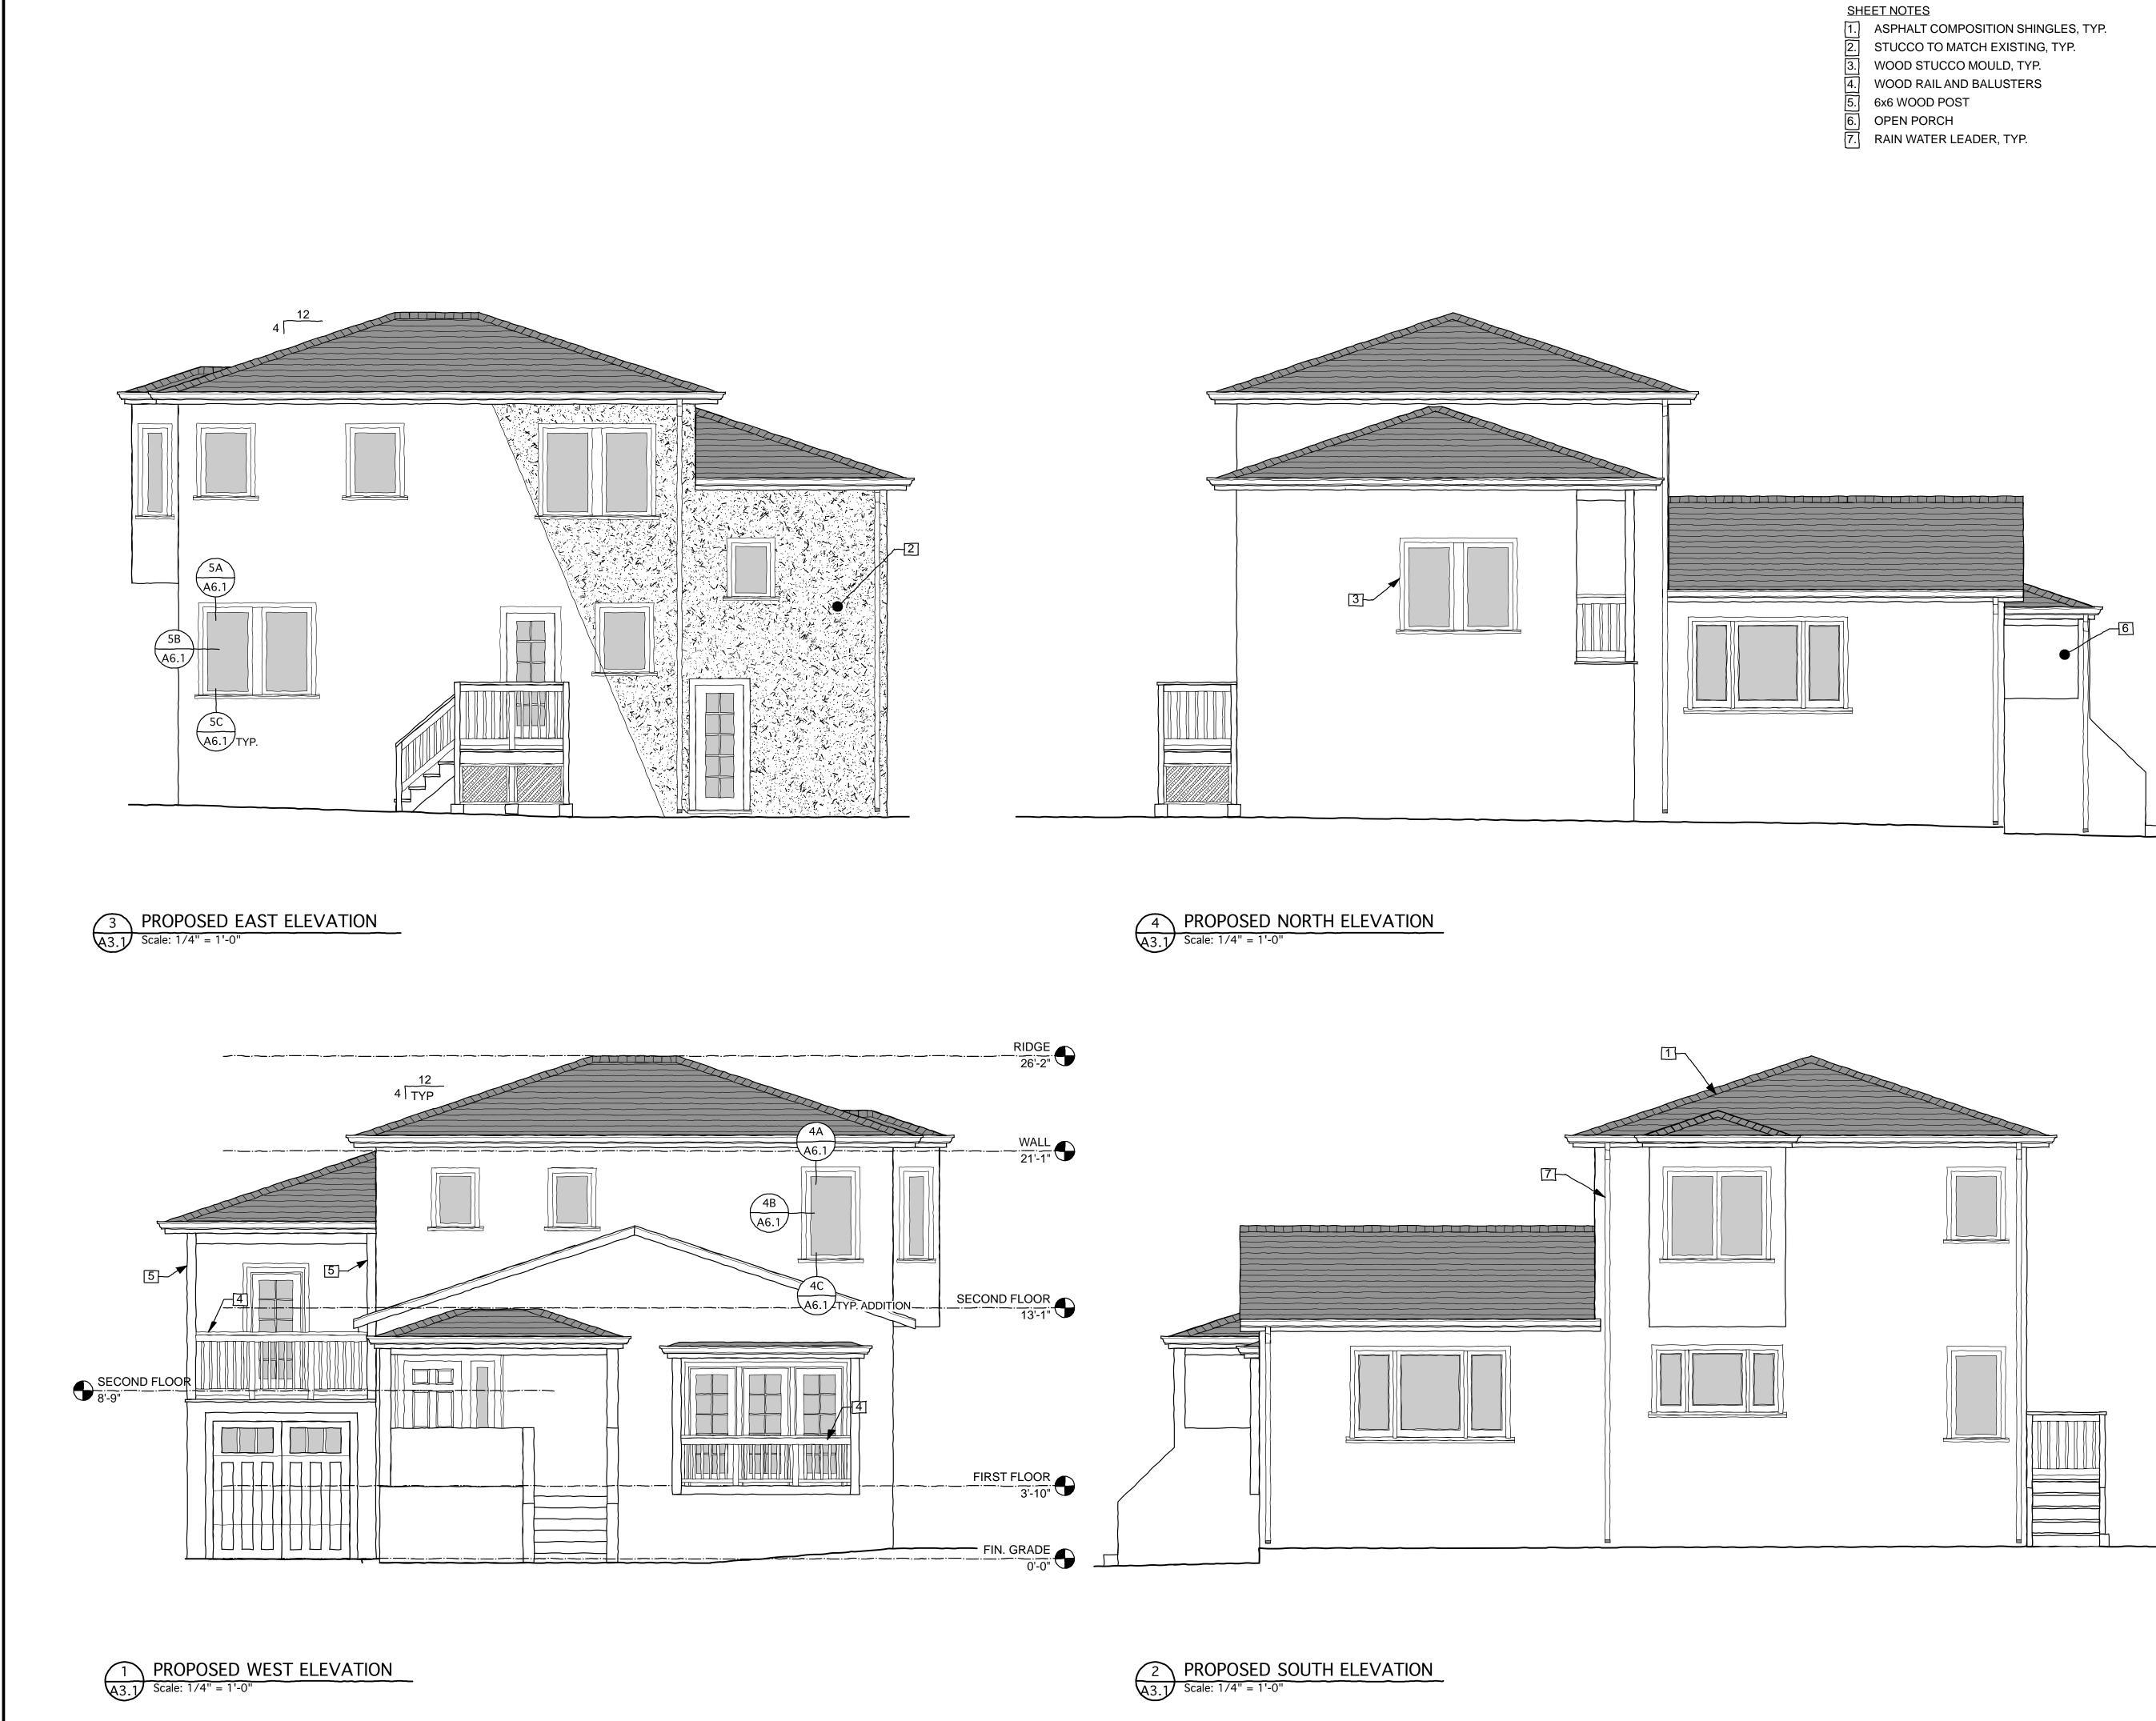

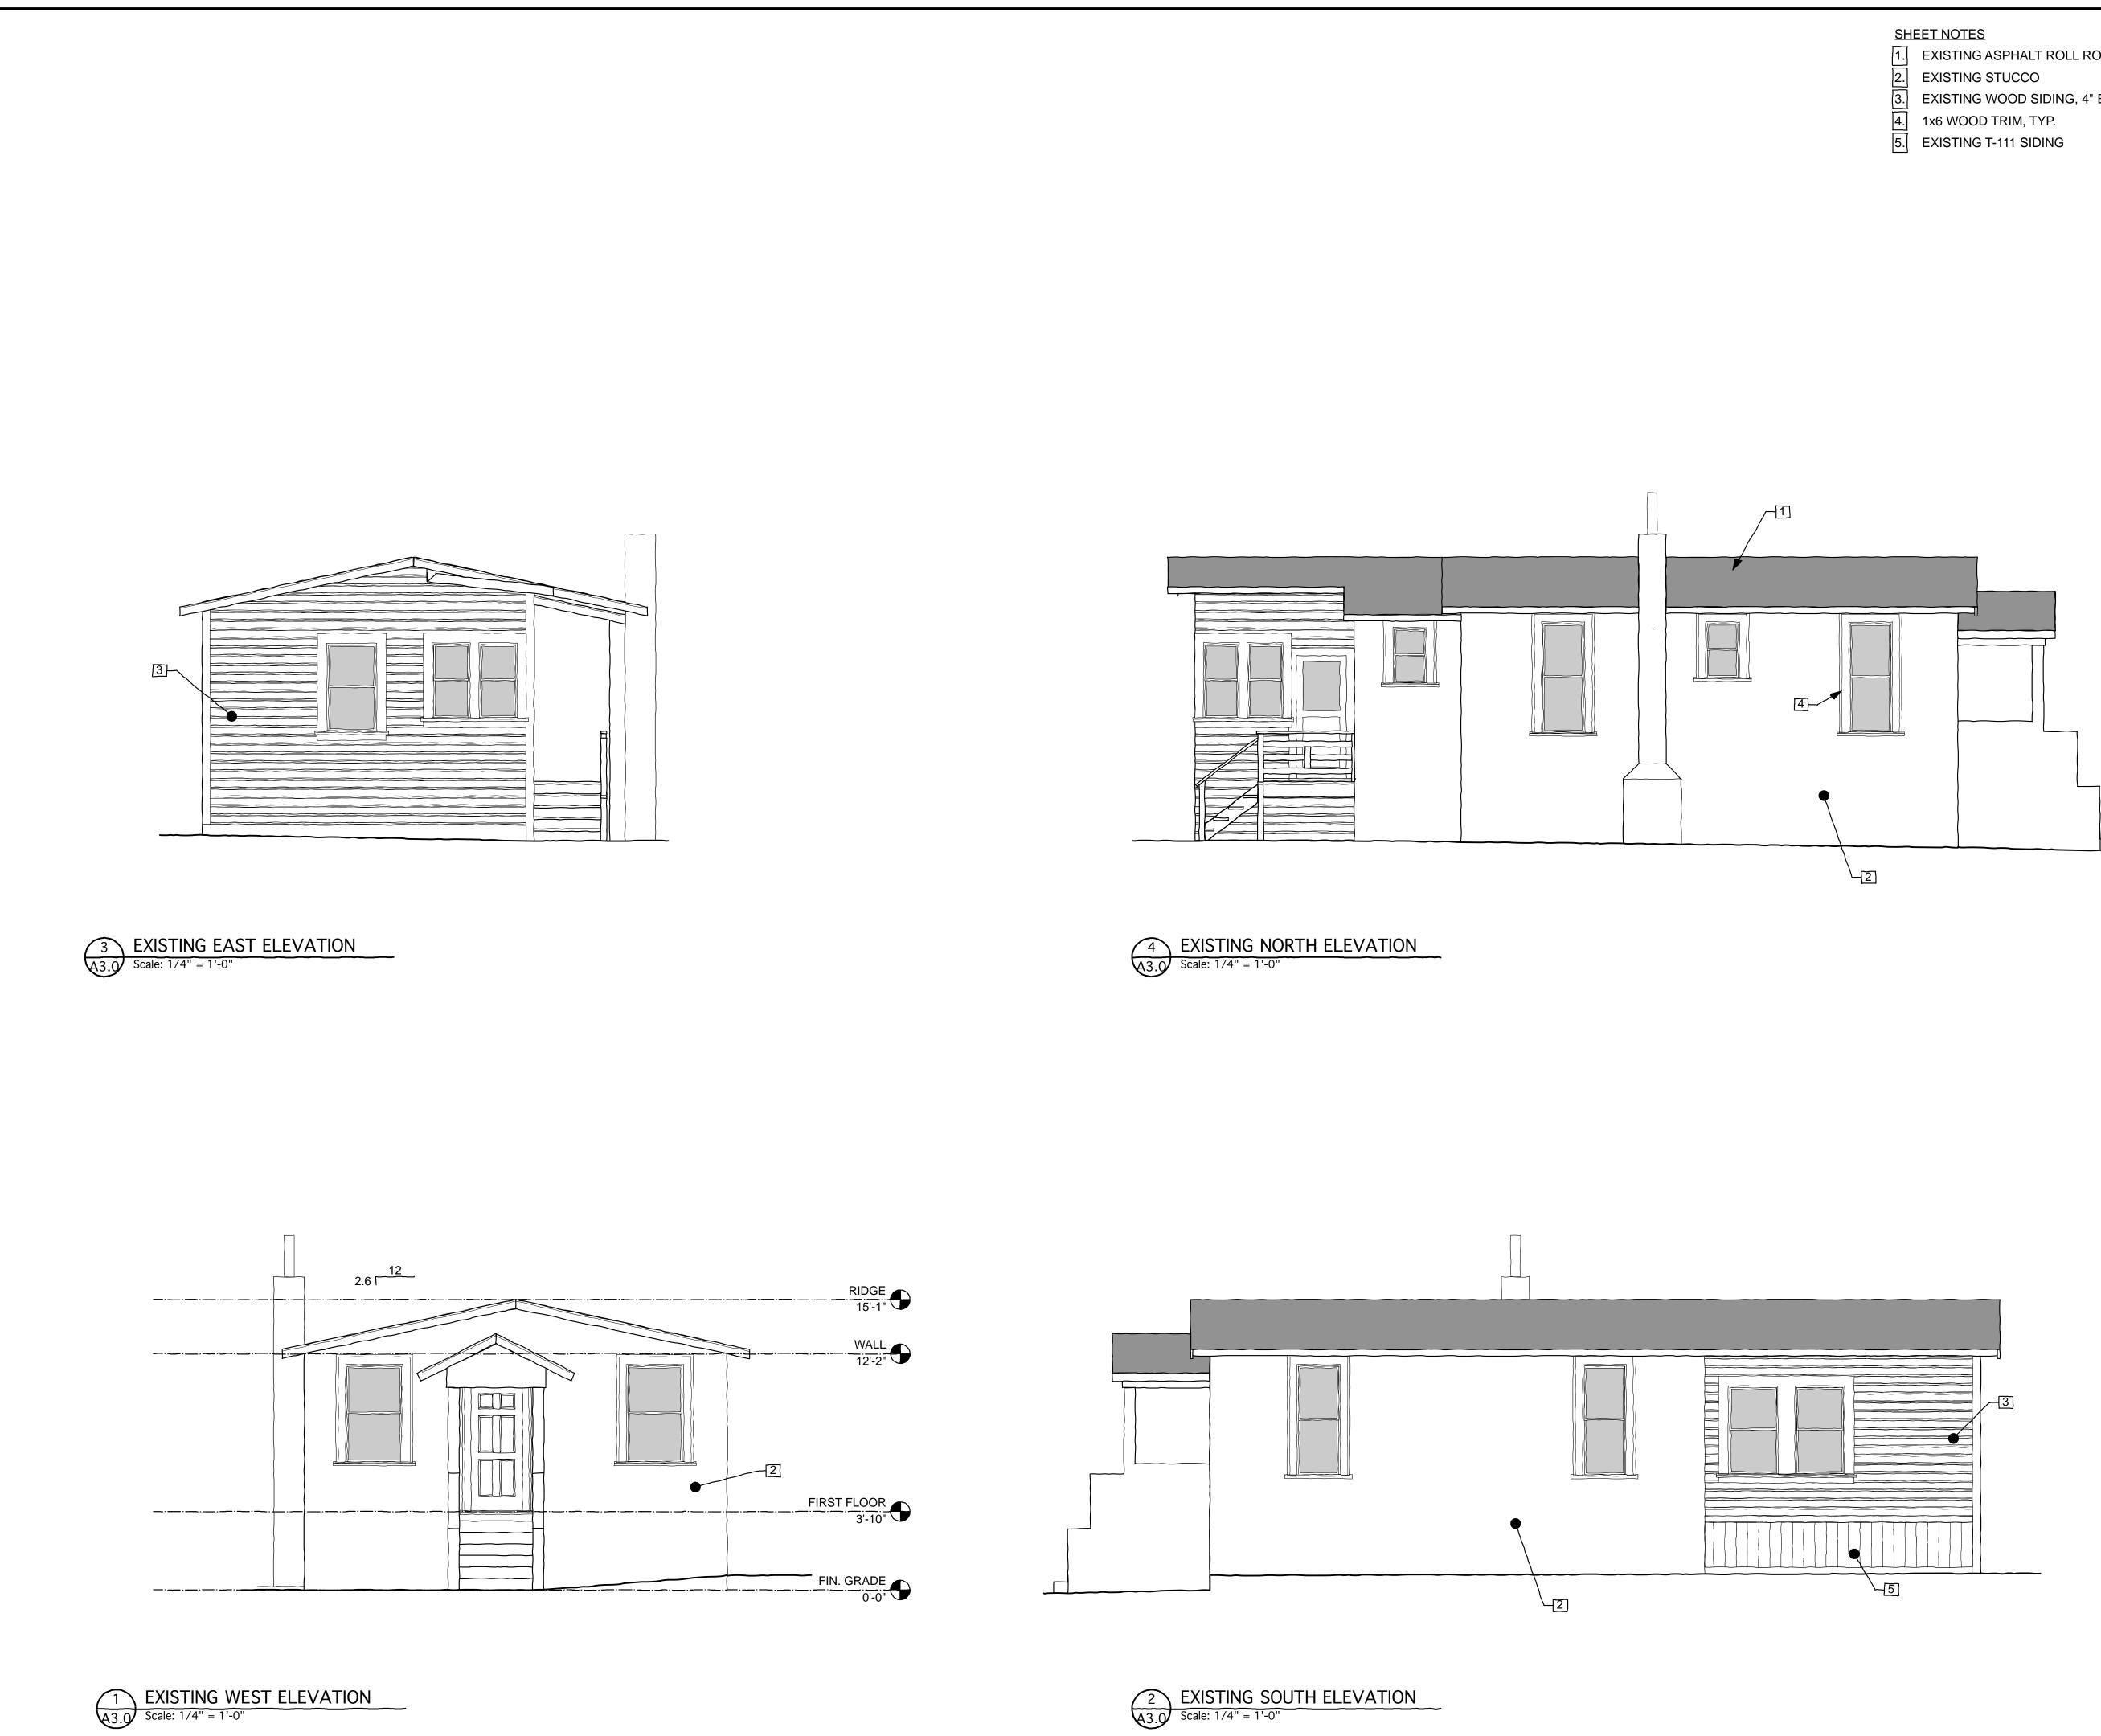
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	DESIGN REVIEW REV	3/3/2025
	DESIGN REVIEW REV	3/28/2025
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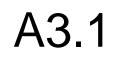
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	DESIGN REVIEW REV	1/6/2025		
	DESIGN REVIEW REV	3/3/2025		
	DESIGN REVIEW REV	3/28/2025		
SHEE	SHEET TITLE:			
PROPOSED EXTERIOR ELEVATIONS				





F -ROOF COLOR ASPHALT SHINGLES



D -WINDOW COLOR MARVIN FIBERGLASS



C -WINDOW/DOOR TRIM COLOR















G -DECK COLOR REDWOOD - SEALED

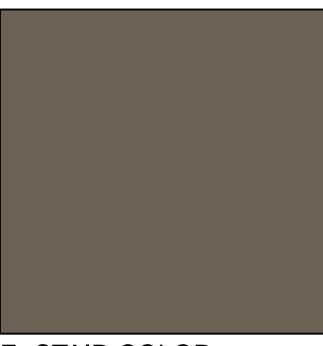


E -STAIR COLOR CONCRETE

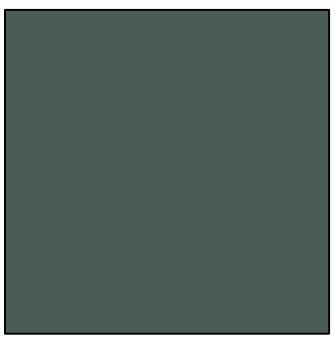


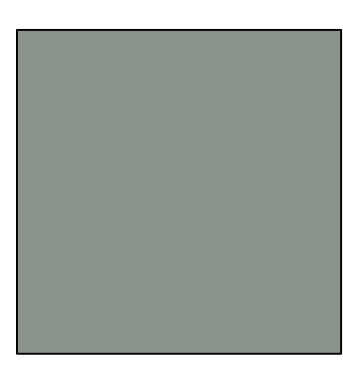


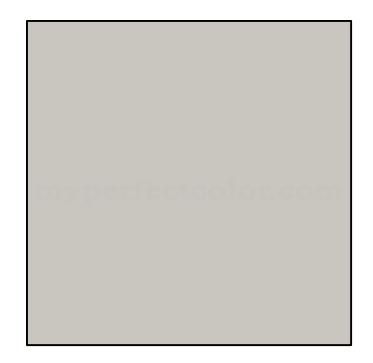

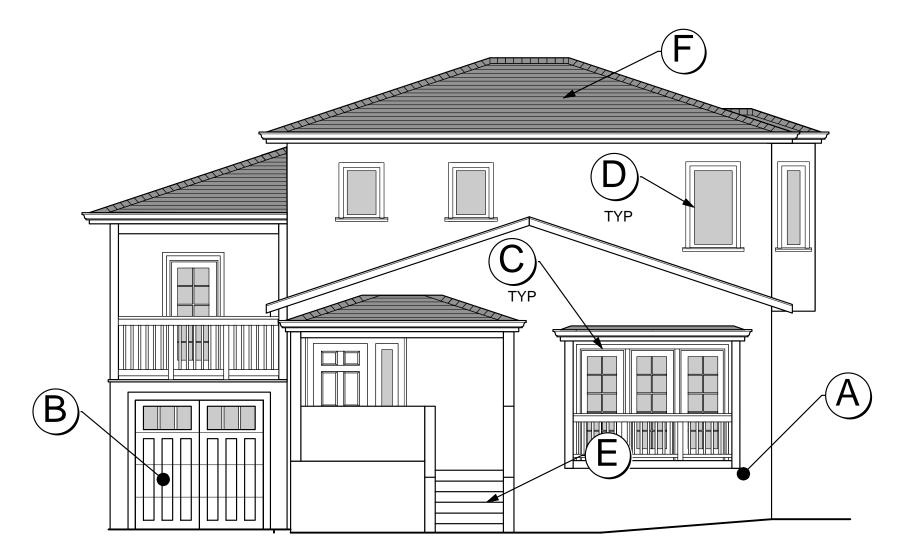




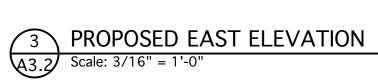

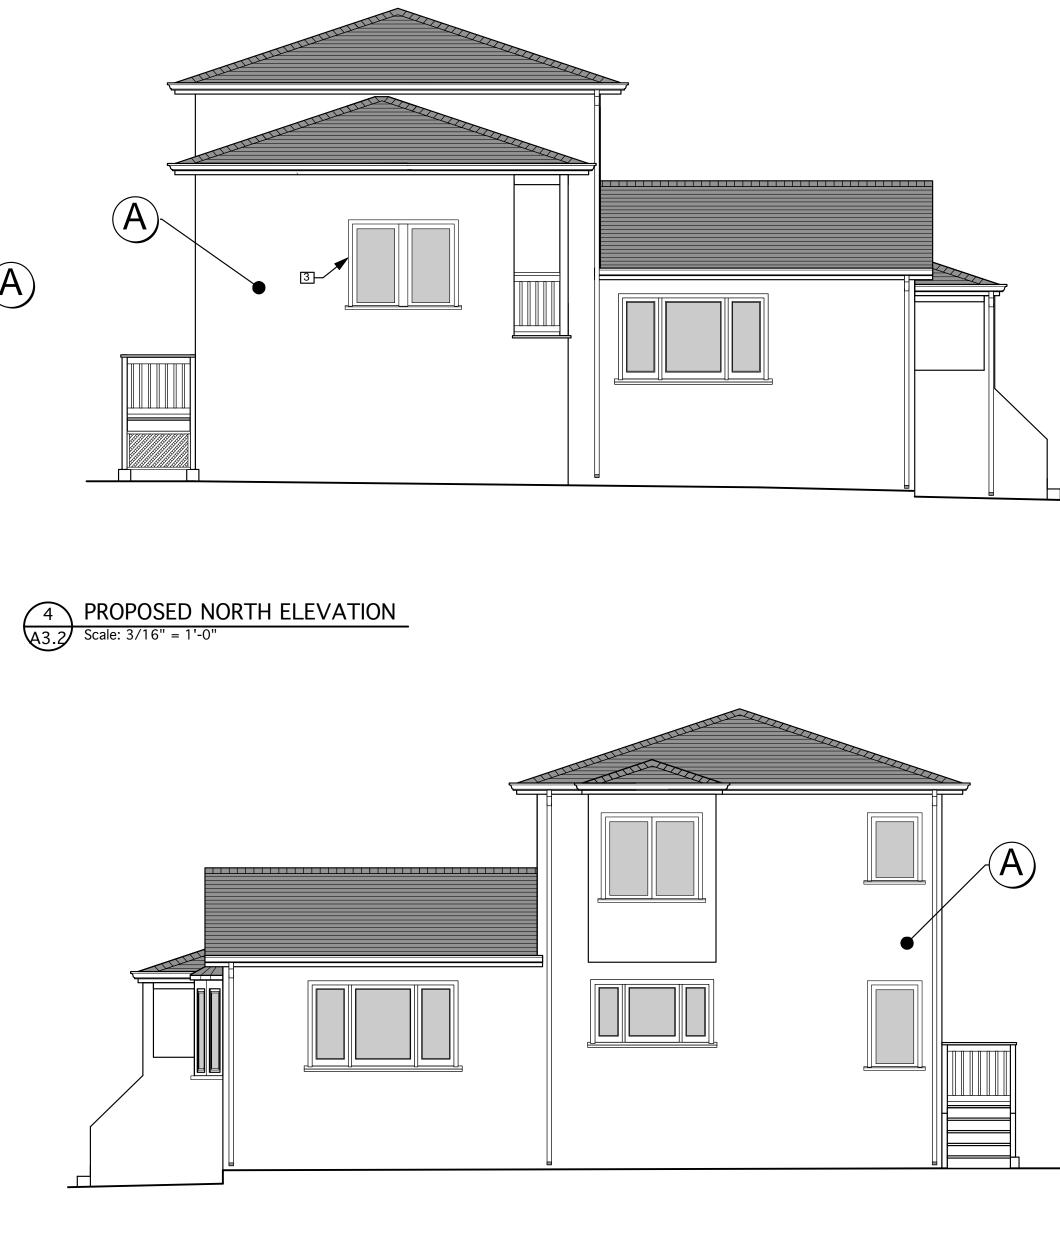



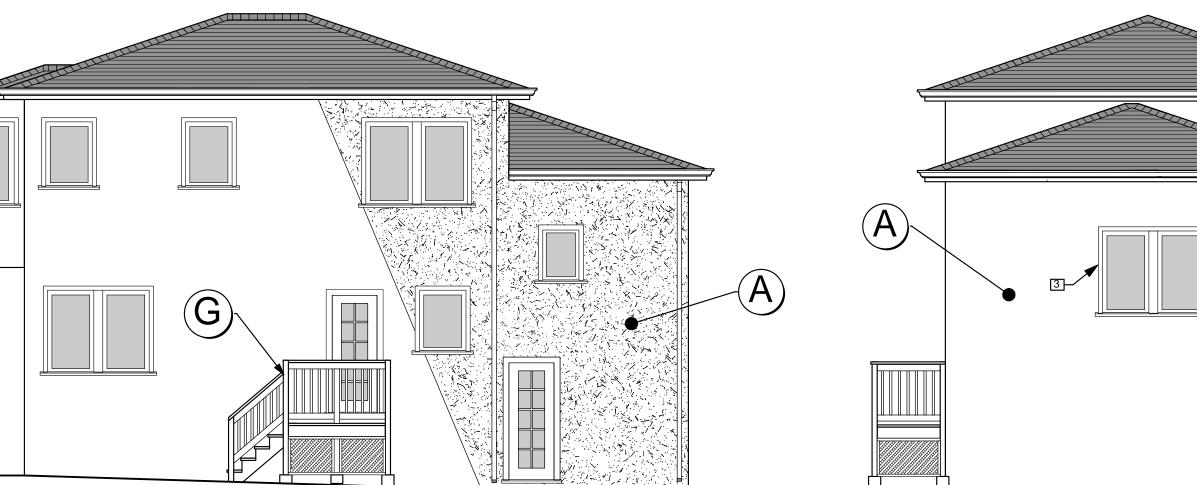

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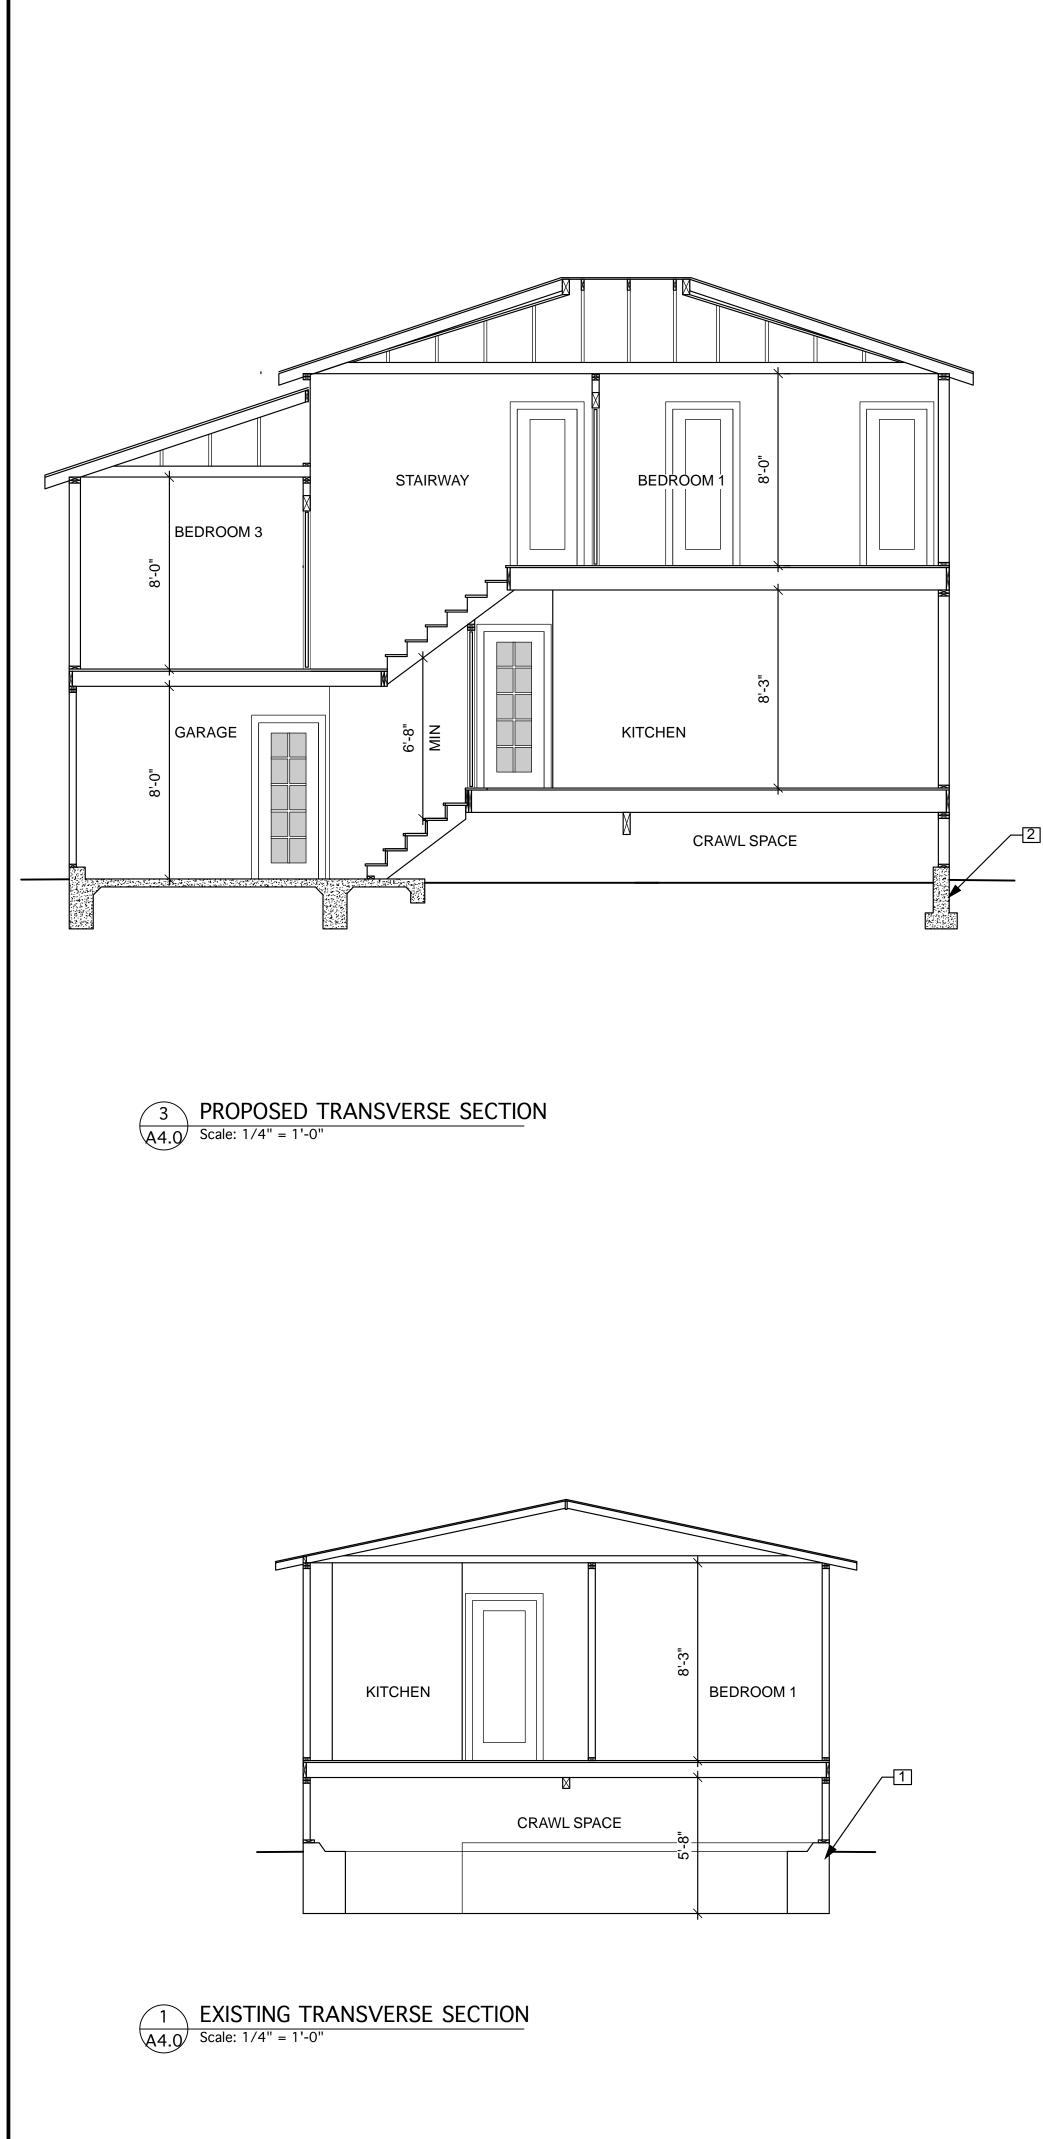
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	DESIGN REVIEW REV	3/3/2025						
	DESIGN REVIEW REV	3/28/2025						
SHEE	T TITLE:							
	SHEET TITLE: MATERIALS AND COLORS							


A3.2

SHEET NUMBER:


2 PROPOSED SOUTH ELEVATION A3.2 Scale: 3/16" = 1'-0"





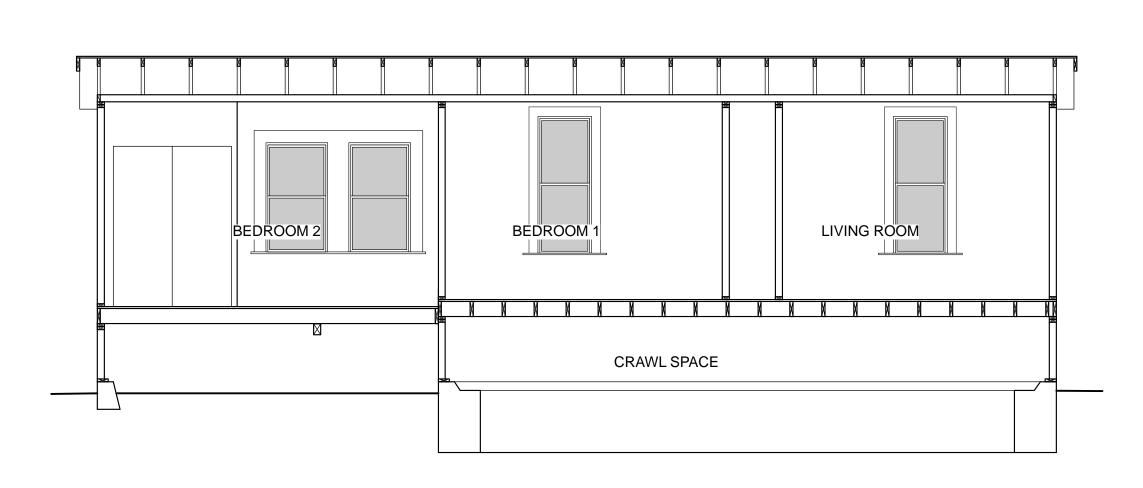



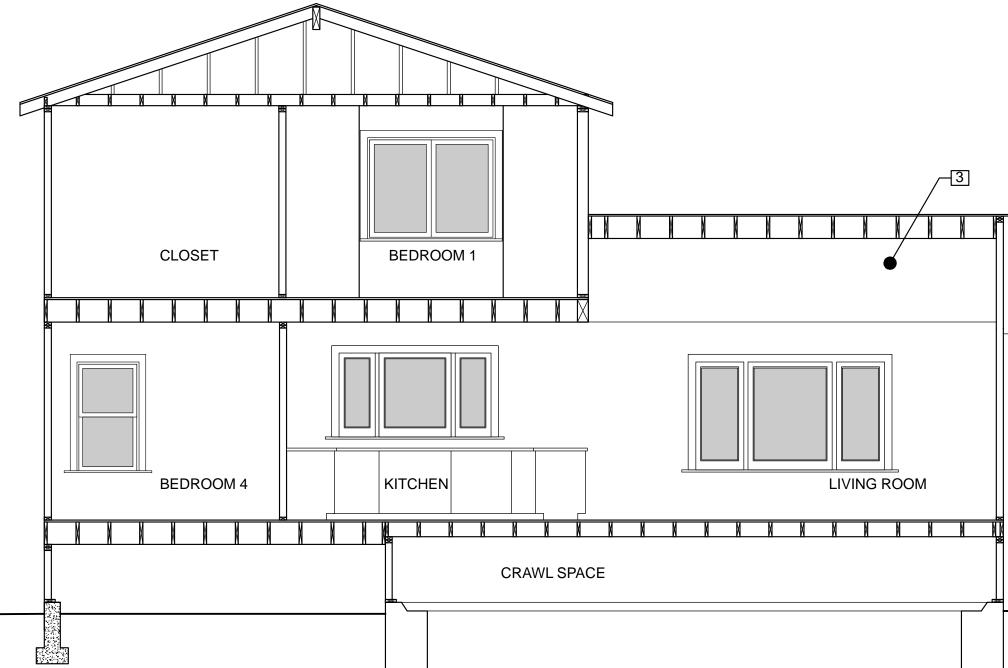

SHEET NOTES



- NEW CONCRETE FOUNDATION, TYP.
- 3. VAULTED CEILING

/-3 LIVING ROOM

HARTIGAN RCHITECTURE

MICHAEL HARTIGAN, AIA ARCHITECT

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Consultants

LEUNG TRUONG RESIDENCE ADDITION

625 EVELYN AVENUE ALBANY, CA 94706



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DATE: 9/1/2021 JOB: 20185 SCALE: As Noted Date Description No DESIGN REVIEW 7/16/2024 _____ DESIGN REVIEW CMTS 11/16/2024 DESIGN REVIEW REV 1/6/2025 DESIGN REVIEW REV 3/3/2025 DESIGN REVIEW REV 3/28/2025 SHEET TITLE: BUILDING SECTIONS



NO.	ROOM	EXISTING WINDOW TYPE	NEW WINDOW TYPE	EXISTING WINDOW MATERIAL	NEW WINDOW MATERIAL	EXISTING SIZE (width) x (depth)	NEW SIZE (width) x (depth)	MUNTINS/ GRIDS
Example	Kitchen	Double-hung	Casement	Wood	Alum-Clad with Wood core	48" x 36"	96" x 72"	3 4" x 1 4" (width) x (depth)
E1	Living Room	Single-hung	_	Aluminum	_	3'0" x 5'0"	—	
E2	Living Room	Single-hung		Aluminum	_	3'0" x 5'0"	—	
E3	Living Room	Single-hung	—	Aluminum	—	2'8" x 5'8"	—	
E4	Bath 1	Single-hung		Aluminum	_	1'8" x 2'10"	—	
E5	Kitchen	Single-hung	—	Aluminum	—	2'2" x 5'8"	—	
E6	Kitchen	Single-hung		Aluminum	_	1'8" x 2'4"	—	
E7	Porch	Single-hung	—	Aluminum	—	2'0" x 3'4"	—	
E8	Porch	Single-hung	—	Aluminum	_	2'0" x 3'4"	—	
E9	Porch	Single-hung	—	Aluminum	—	2'0" x 3'4"	—	
E10	Porch	Single-hung	—	Aluminum	_	2'0" x 3'4"	—	
E11	Bedroom 2	Single-hung	—	Aluminum	_	2'6" x 4'6"	—	
E12	Bedroom 2	Single-hung	_	Aluminum	_	2'6" x 4'6"	—	
E13	Bedroom 2	Single-hung	—	Aluminum	_	2'6" x 4'6"	—	
E14	Bedroom 1	Single-hung	_	Aluminum	_	2'2" x 5'8"	—	
E15	Living Room	Single-hung	_	Aluminum	_	2'8" x 5'8"	_	

Window Notes

E1-E15. All existing windows to be removed and replaced.

	ROOM	EXISTING WINDOW TYPE	NEW WINDOW TYPE	EXISTING WINDOW MATERIAL	NEW WINDOW MATERIAL	EXISTING SIZE (width) x (depth)	NEW SIZE (width) x (depth)	MUNTINS/ GRIDS	
Example	Kitchen	Double-hung	Casement	Wood	Alum-Clad with Wood core	48" x 36"	96" x 72"	3/4" x 1/4" (width) x (depth)	
1	Living Room	_	Fixed	—	Fiberglass	_	7'6" x 6'8"	3/4" SDL	
2	Not Used	_	—		_	—	—		
3	Living Room	_	Casement		Fiberglass	_	2'0" x 4'6"		
4	Living Room	_	Fixed		Fiberglass	_	3'6" x 4'6"		
5	Living Room	_	Casement		Fiberglass	_	2'0" x 4'6"		
6	Laundry/Mech	_	Casement	_	Fiberglass	—	2'6" x 3'4"		
7	Bedroom 4	_	Casement	_	Fiberglass	_	2'6" x 4'6"		
8	Bedroom 4	_	Casement	_	Fiberglass	_	2'6" x 4'6"		
9	Bedroom 4	_	Casement		Fiberglass		2'6" x 4'6"		
10	Kitchen	_	Casement		Fiberglass	_	1'6" x 3'2"		
11	Kitchen		Casement		Fiberglass	_	3'0" x 3'2"		
12	Kitchen	_	Casement		Fiberglass	_	1'6" x 3'2"		
13	Living Room		Casement	_	Fiberglass	_	2'0" x 4'6"		
14	Living Room		Fixed	_	Fiberglass	_	3'6" x 4'6"		
15	Living Room		Casement		Fiberglass	_	2'0" x 4'6"		
16	Bedroom 1		Casement	_	Fiberglass	_	2'6" x 4'6"		
17	Hall		Casement	_	Fiberglass	_	2'0" x 2'8"		
18	Bath 2		Casement	_	Fiberglass	_	2'0" x 2'8"		
19	Bedroom 3		Casement		Fiberglass	_	2'6" x 4'6"		
20	Bedroom 3		Casement	_	Fiberglass	_	2'6" x 4'6"		_
21	Bedroom 2		Casement		Fiberglass	_	2'6" x 4'6"		
22	Bedroom 2		Casement	_	Fiberglass	_	2'6" x 4'6"		_
23	Closet		Casement		Fiberglass		2'6" x 3'6"		
24	Bath 1		Casement		Fiberglass		2'6" x 3'6"		
25	Bath 1		Casement		Fiberglass		2'6" x 3'6"		
26	Bedroom 1		Fixed		Fiberglass		1'2" x 4'6"		
27	Bedroom 1		Casement Pair		Fiberglass		5'0" x 4'6"		
28	Bedroom 1		Fixed		Fiberglass		1'2" x 4'6"		╉
29	Closet		Casement		Fiberglass		2'0" x 2'8"		

Window Notes

General: •New windows to be Milgard Ultra series C650 fiberglass units unless otherwise noted. •Verify all sizes in field •Minimum U-factor - .30, Minimum SHGC - NA

Note 1 Tempered glass

Note 2 Egress Window Note 3 With simulated check rail Note 4 3 unit Fixed Windows; Simulated Divided lite, see 3/A6.1

DOOR SCHEDULE							1		
Mark	Size	Thickness	Туре	Composition	Finish	Head	tail Referer	nce Sill	Notes
				•		пеац	Janib	3111	
100A	7/0 x 7/0	1 3/4"	Overhead	Wood	Painted				Note 1
100B	2/6 x 6/8	1 3/4"	10 Lite	Fiberglass					Notes 1, 2
100C	2/6 x 6/8	1 3/8"	Flush	Wood	Painted				Notes 1, 4
101A	3/0 x 6/8	1 3/4"	8 Panel	Wood					Notes 1, 3
103A	2/8x 6/8	1 3/8"	1 Panel	Wood	Painted				Note 1
103B	5/0x 6/8	1 3/8"	Slider Pair	Wood	Painted				Note 1
105A	2/8x 6/8	1 3/8"	1 Panel	Wood	Painted				Note 1
106A	2/6 x 6/8	1 3/8"	1 Panel	Wood	Painted				Note 1
107A	2/6 x 6/8	1 3/4"	10 Lite	Fiberglass					Notes 1, 2
201A	2/8x 6/8	1 3/8"	1 Panel	Wood	Painted				Note 1
202A	2/6 x 6/8	1 3/8"	1 Panel	Wood	Painted				Note 1
203A	2/6 x 6/8	1 3/8"	1 Panel	Wood	Painted				Note 1
204A	2/8x 6/8	1 3/8"	1 Panel	Wood	Painted				Note 1
204B	5/0x 6/8	1 3/8"	Slider Pair	Wood	Painted				Note 1
205A	2/6 x 6/8	1 3/8"	1 Panel	Wood	Painted				Note 1
205B	2/6 x 6/8	1 3/4"	10 Lite	Fiberglass					Notes 1, 2
205C	2/6 x 6/8	1 3/8"	1 Panel	Wood	Painted				Note 1
206A	2/6 x 6/8	1 3/8"	1 Panel	Wood	Painted				Note 1

Door Notes


General: New exterior fiberglass doors to be Milgard Ultra series C650.


- Selected by Owner Tempered Glass with simulated divided lite; See 3/A6.1 With Sidelite
- 4. Self-closing, Self-latching, Solid Wood, Weather Stripped Door





Window #	Comments	Notes
1	New window location.	Note 4
2	Not Used	
3	New window location.	
4	New window location.	
5	New window location.	
6	New window location.	
7	New window location.	
8	New window location.	
9	New window location.	
10	New window location.	
11	New window location.	
12	New window location.	
13	New window location.	
14	New window location.	
15	New window location.	
16	New window location.	
17	New window location.	
18	New window location.	Note 1
19	New window location.	
20	New window location.	
21	New window location.	
22	New window location.	
23	New window location.	
24	New window location.	Note 1
25	New window location.	Note 1
26	New window location.	
27	New window location.	
28	New window location.	
29	New window location.	

$\overline{4}$	WINDOW DETAIL
A6.1	Scale: 3" = 1'-0"

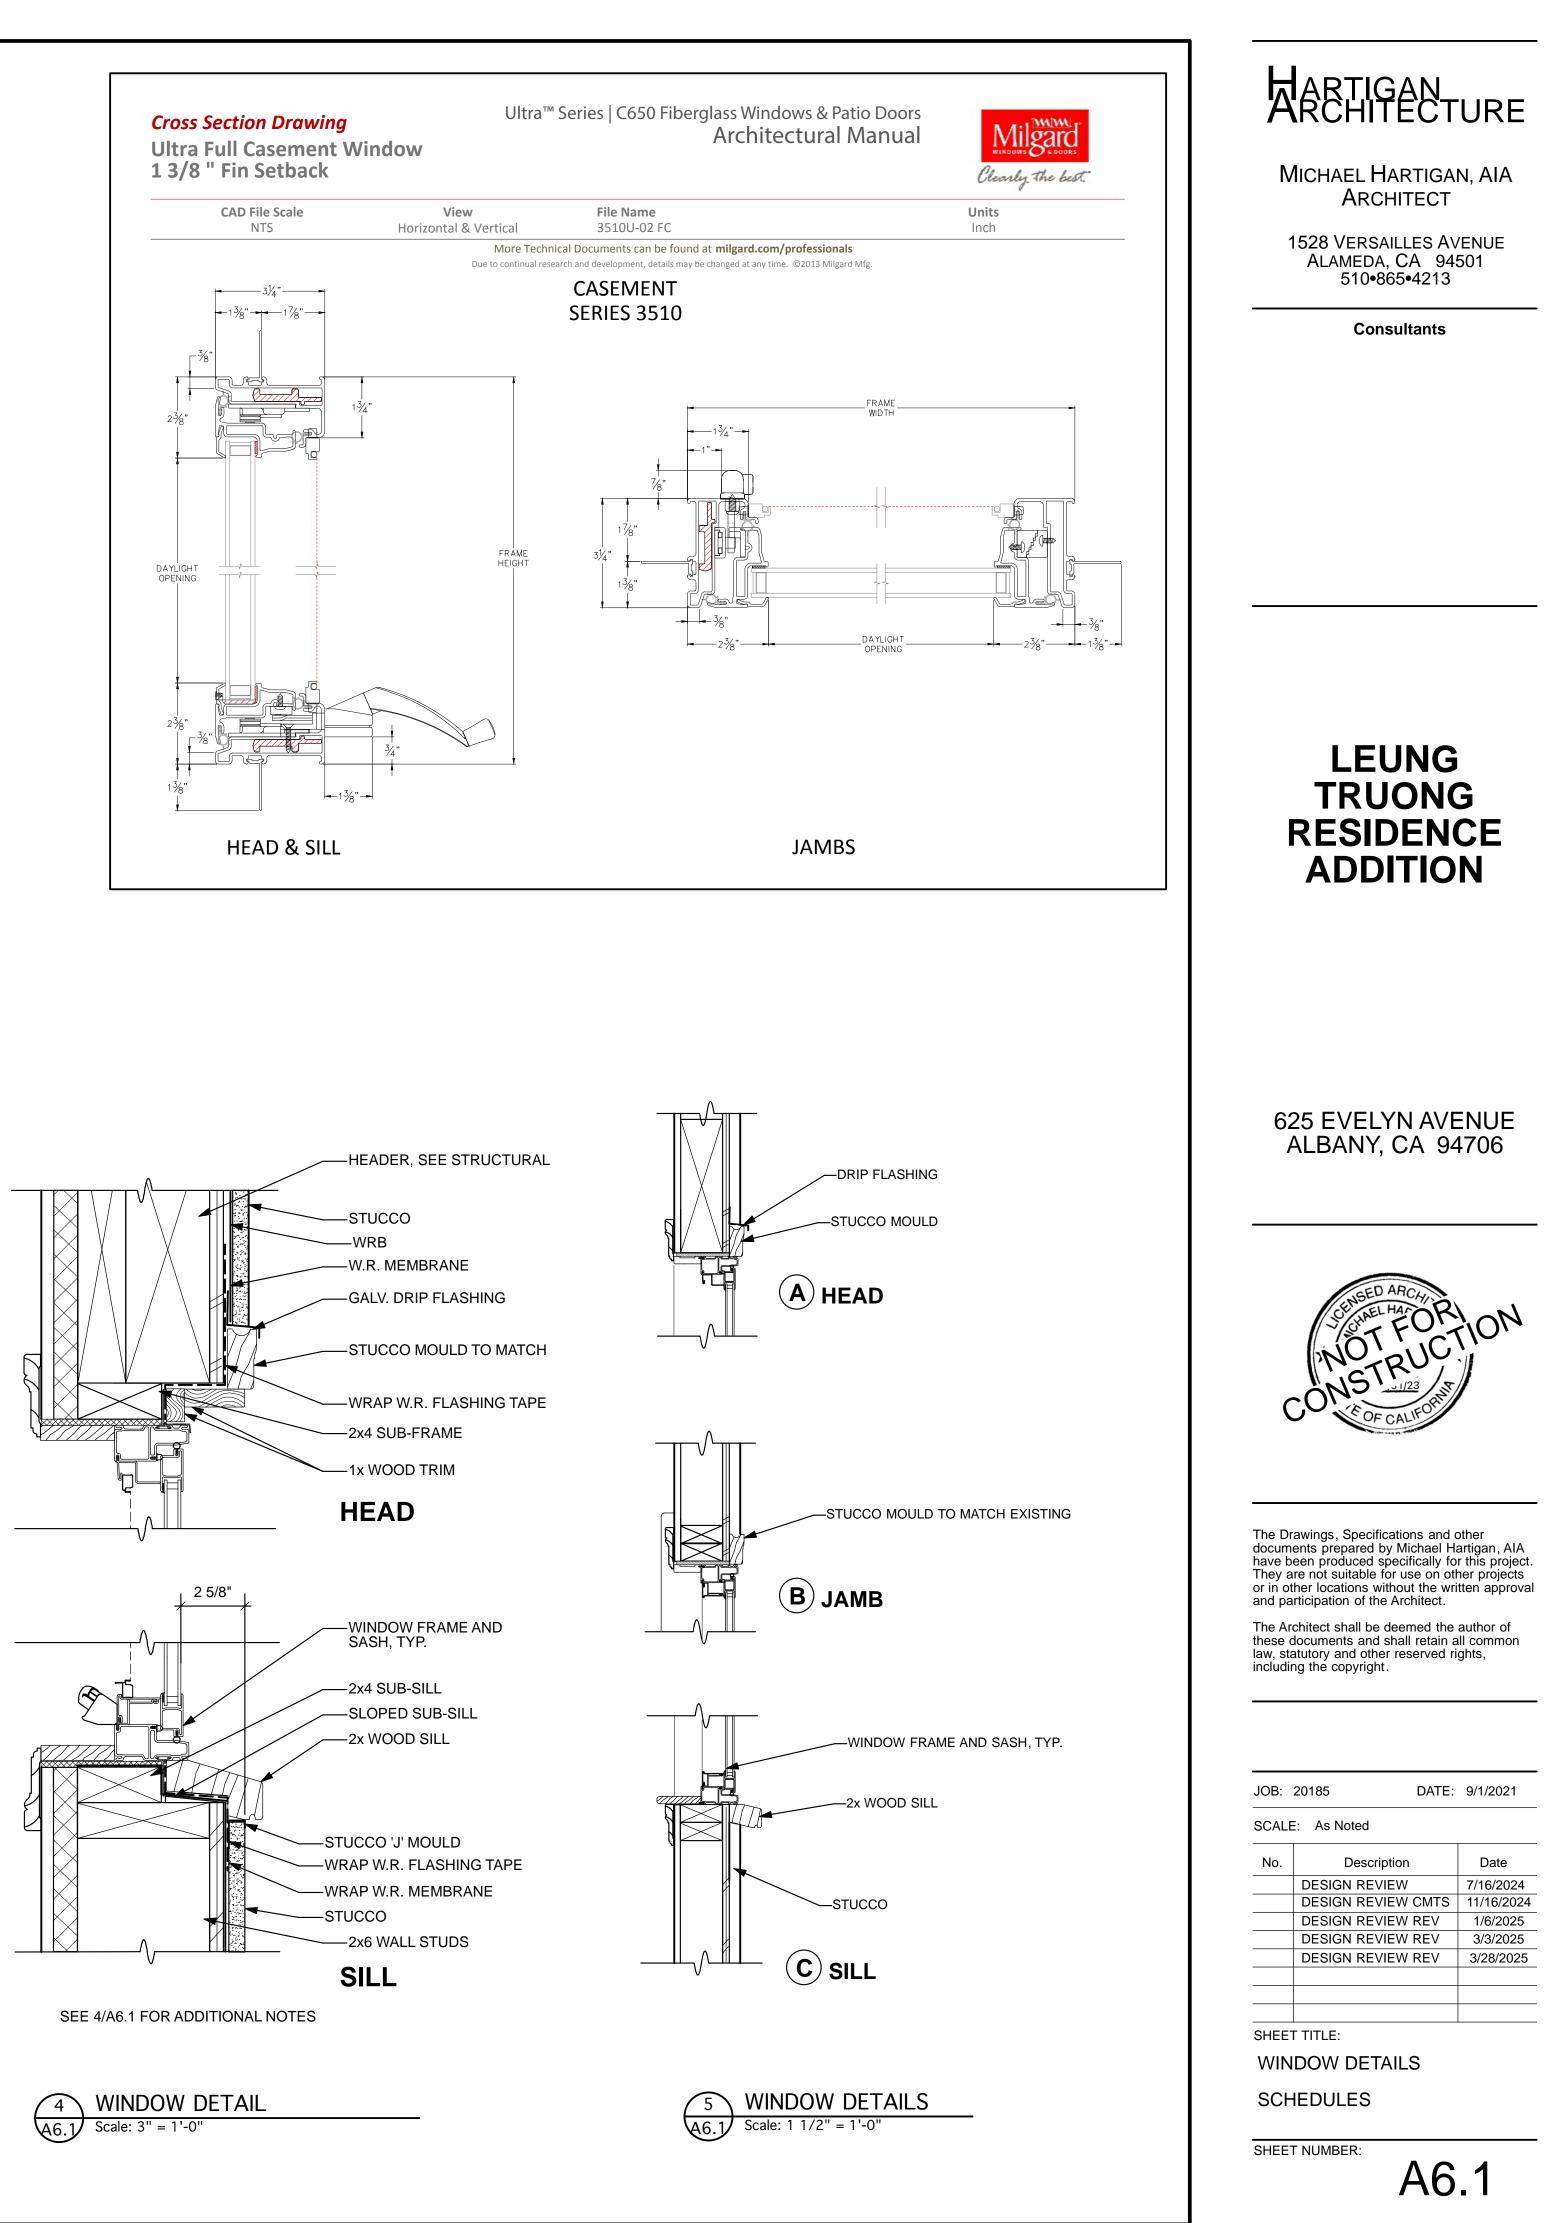

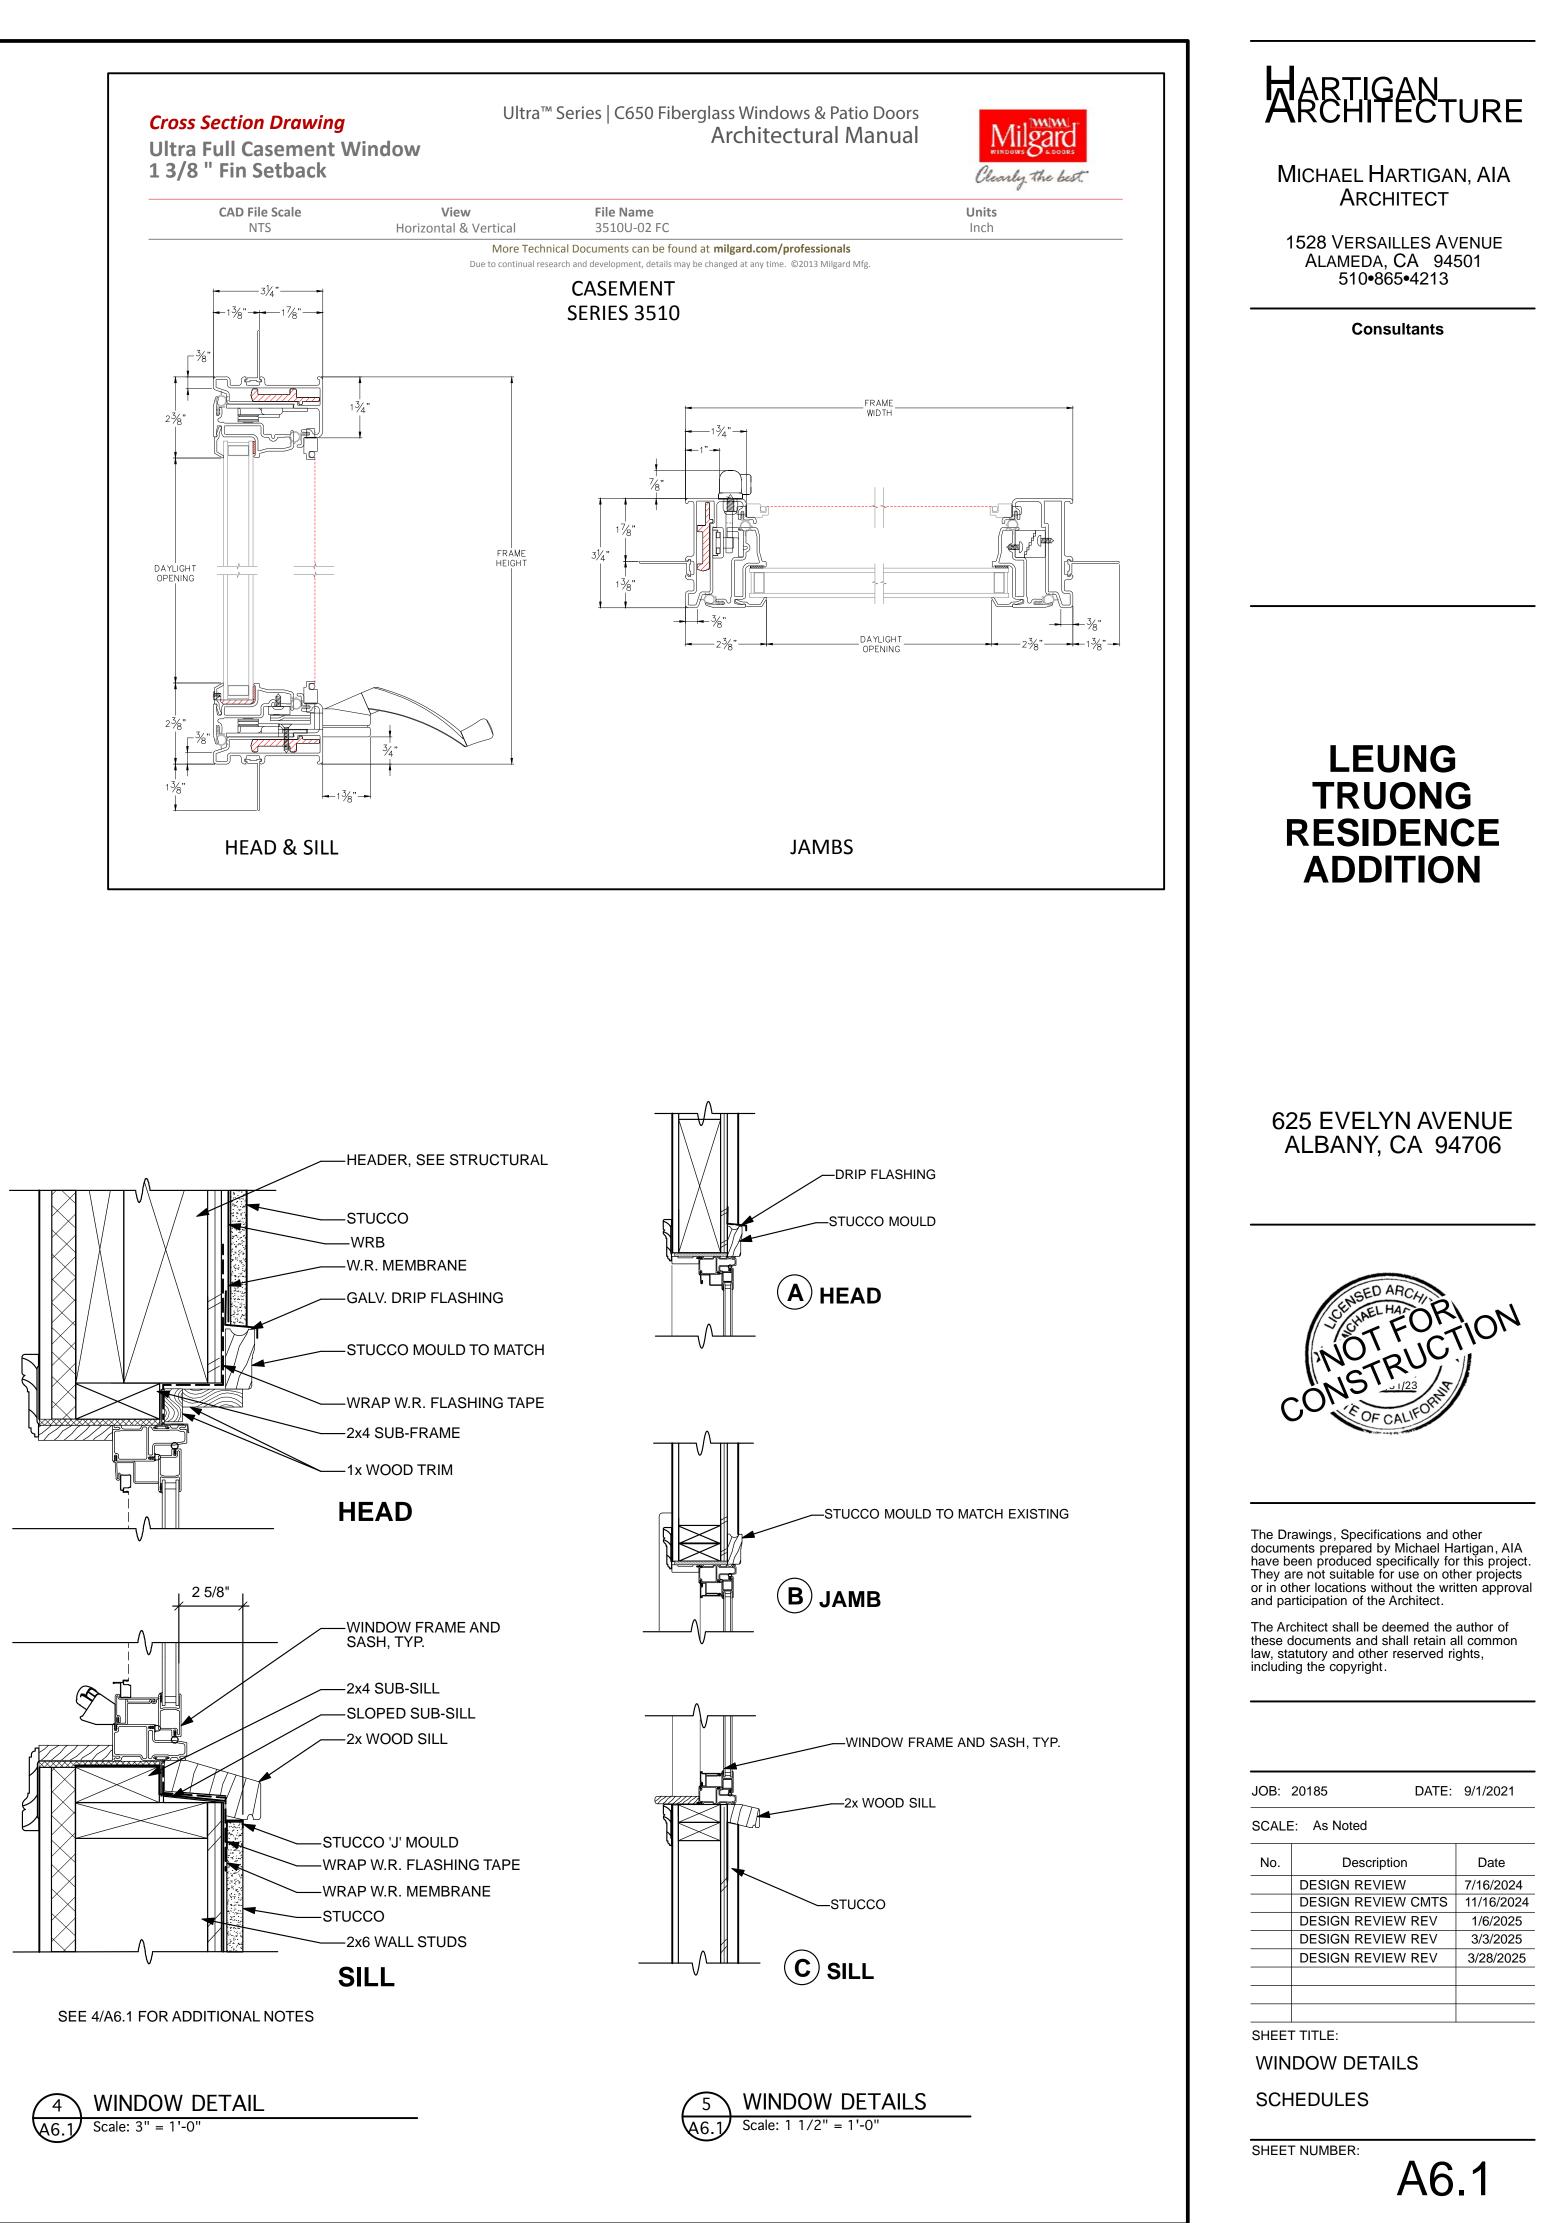

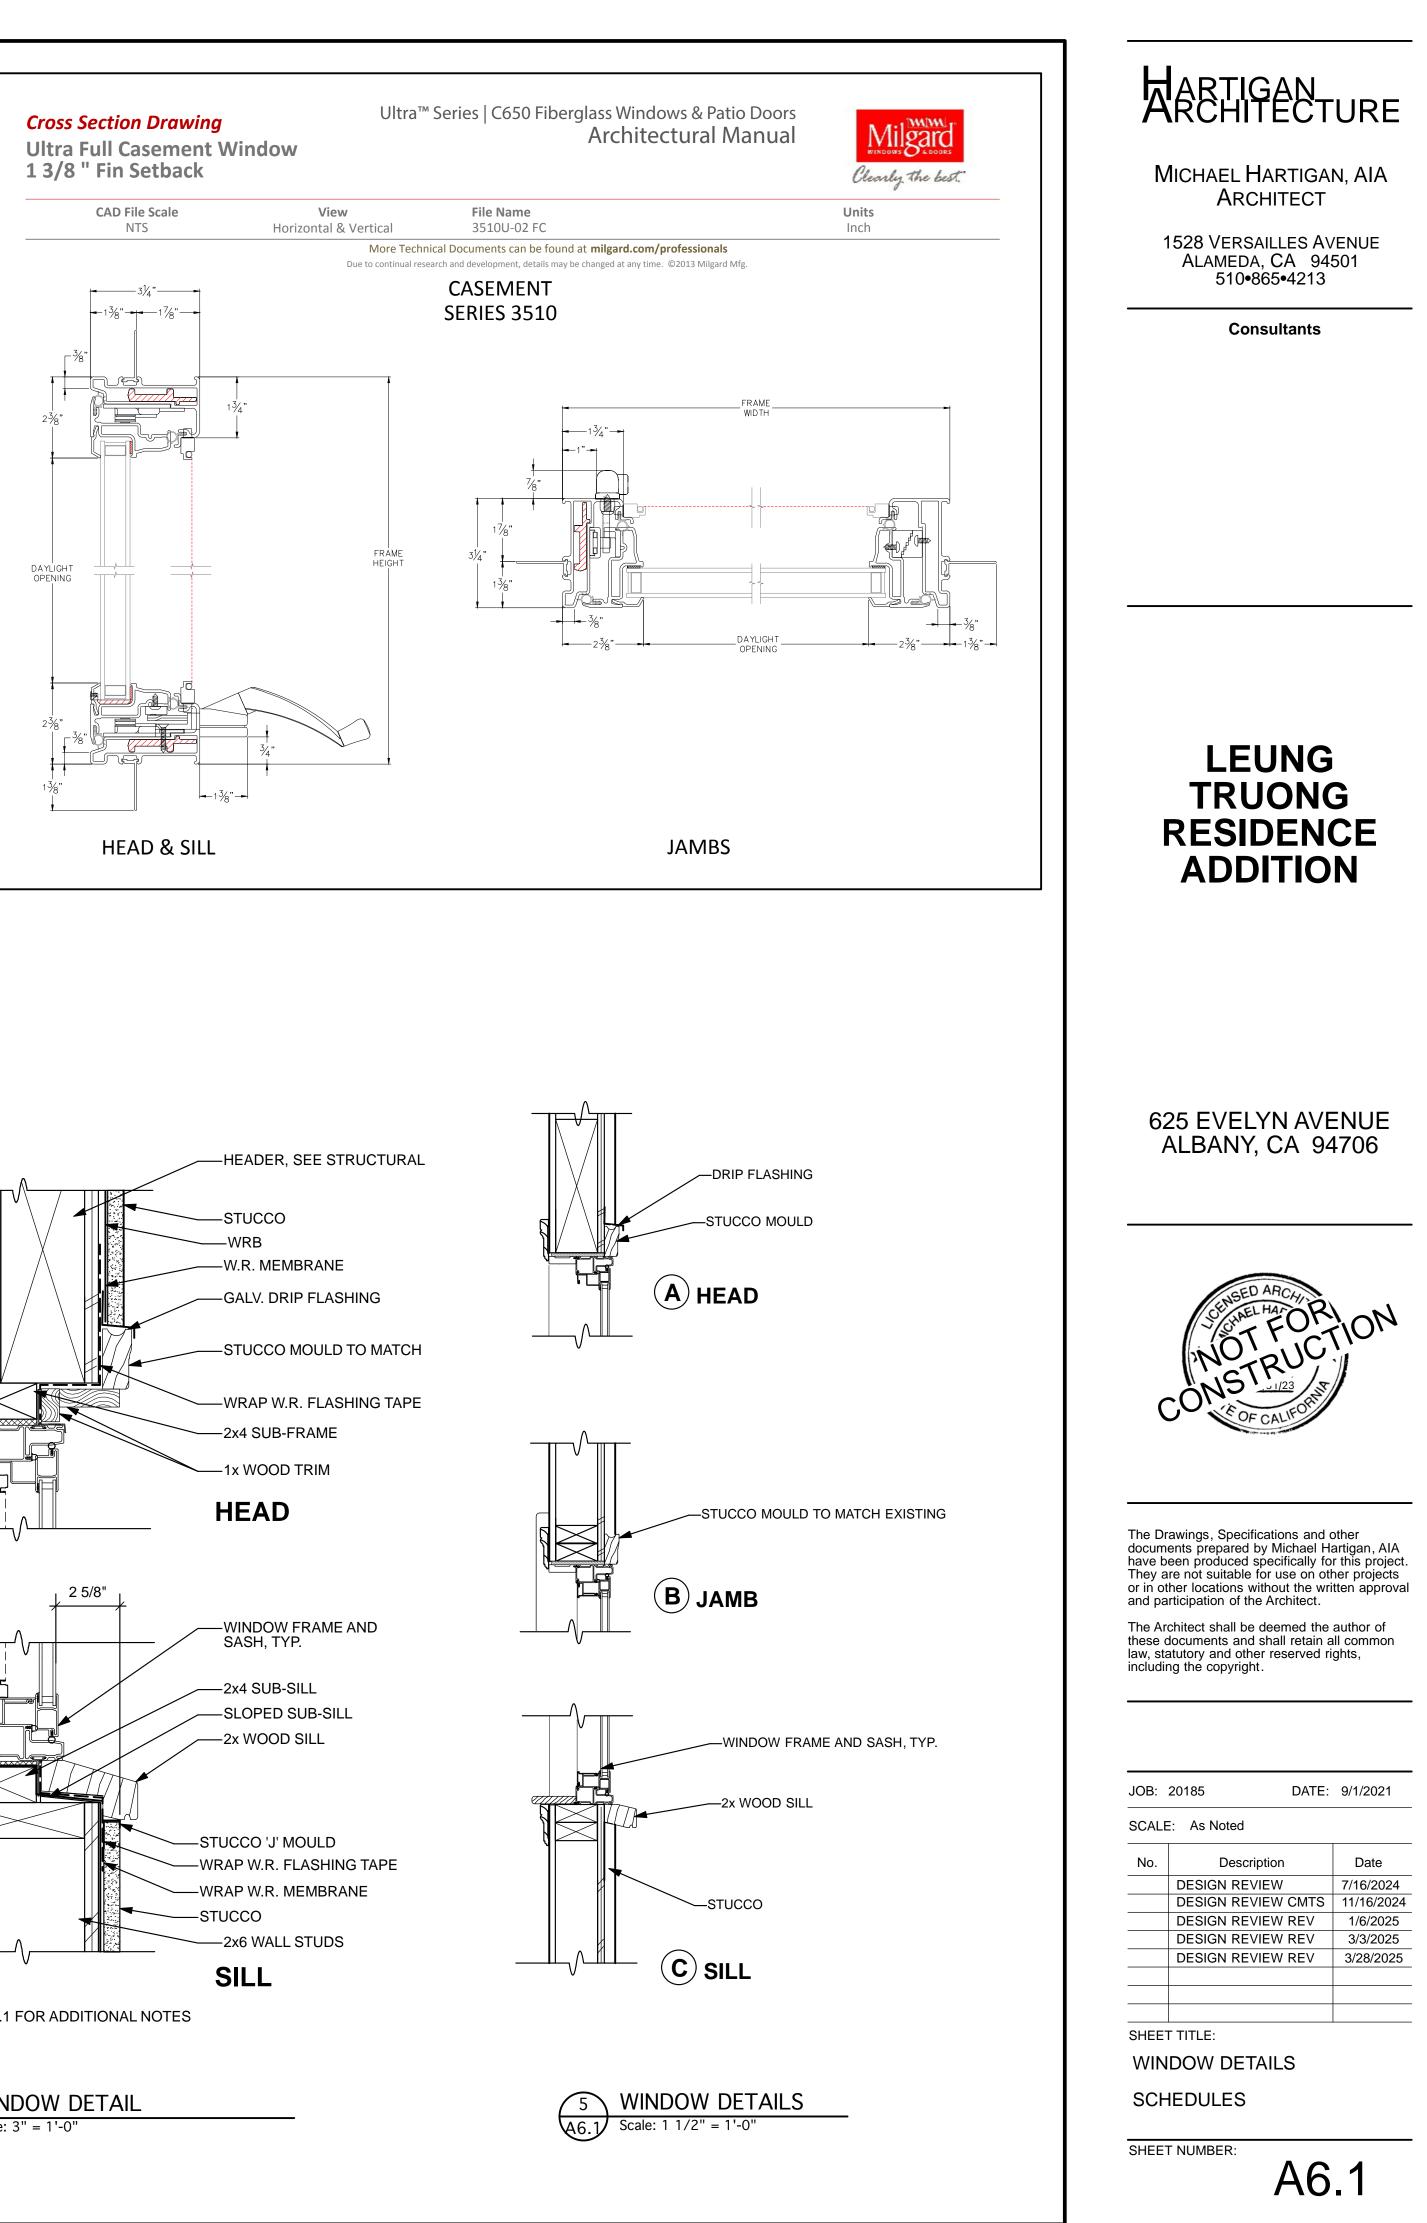

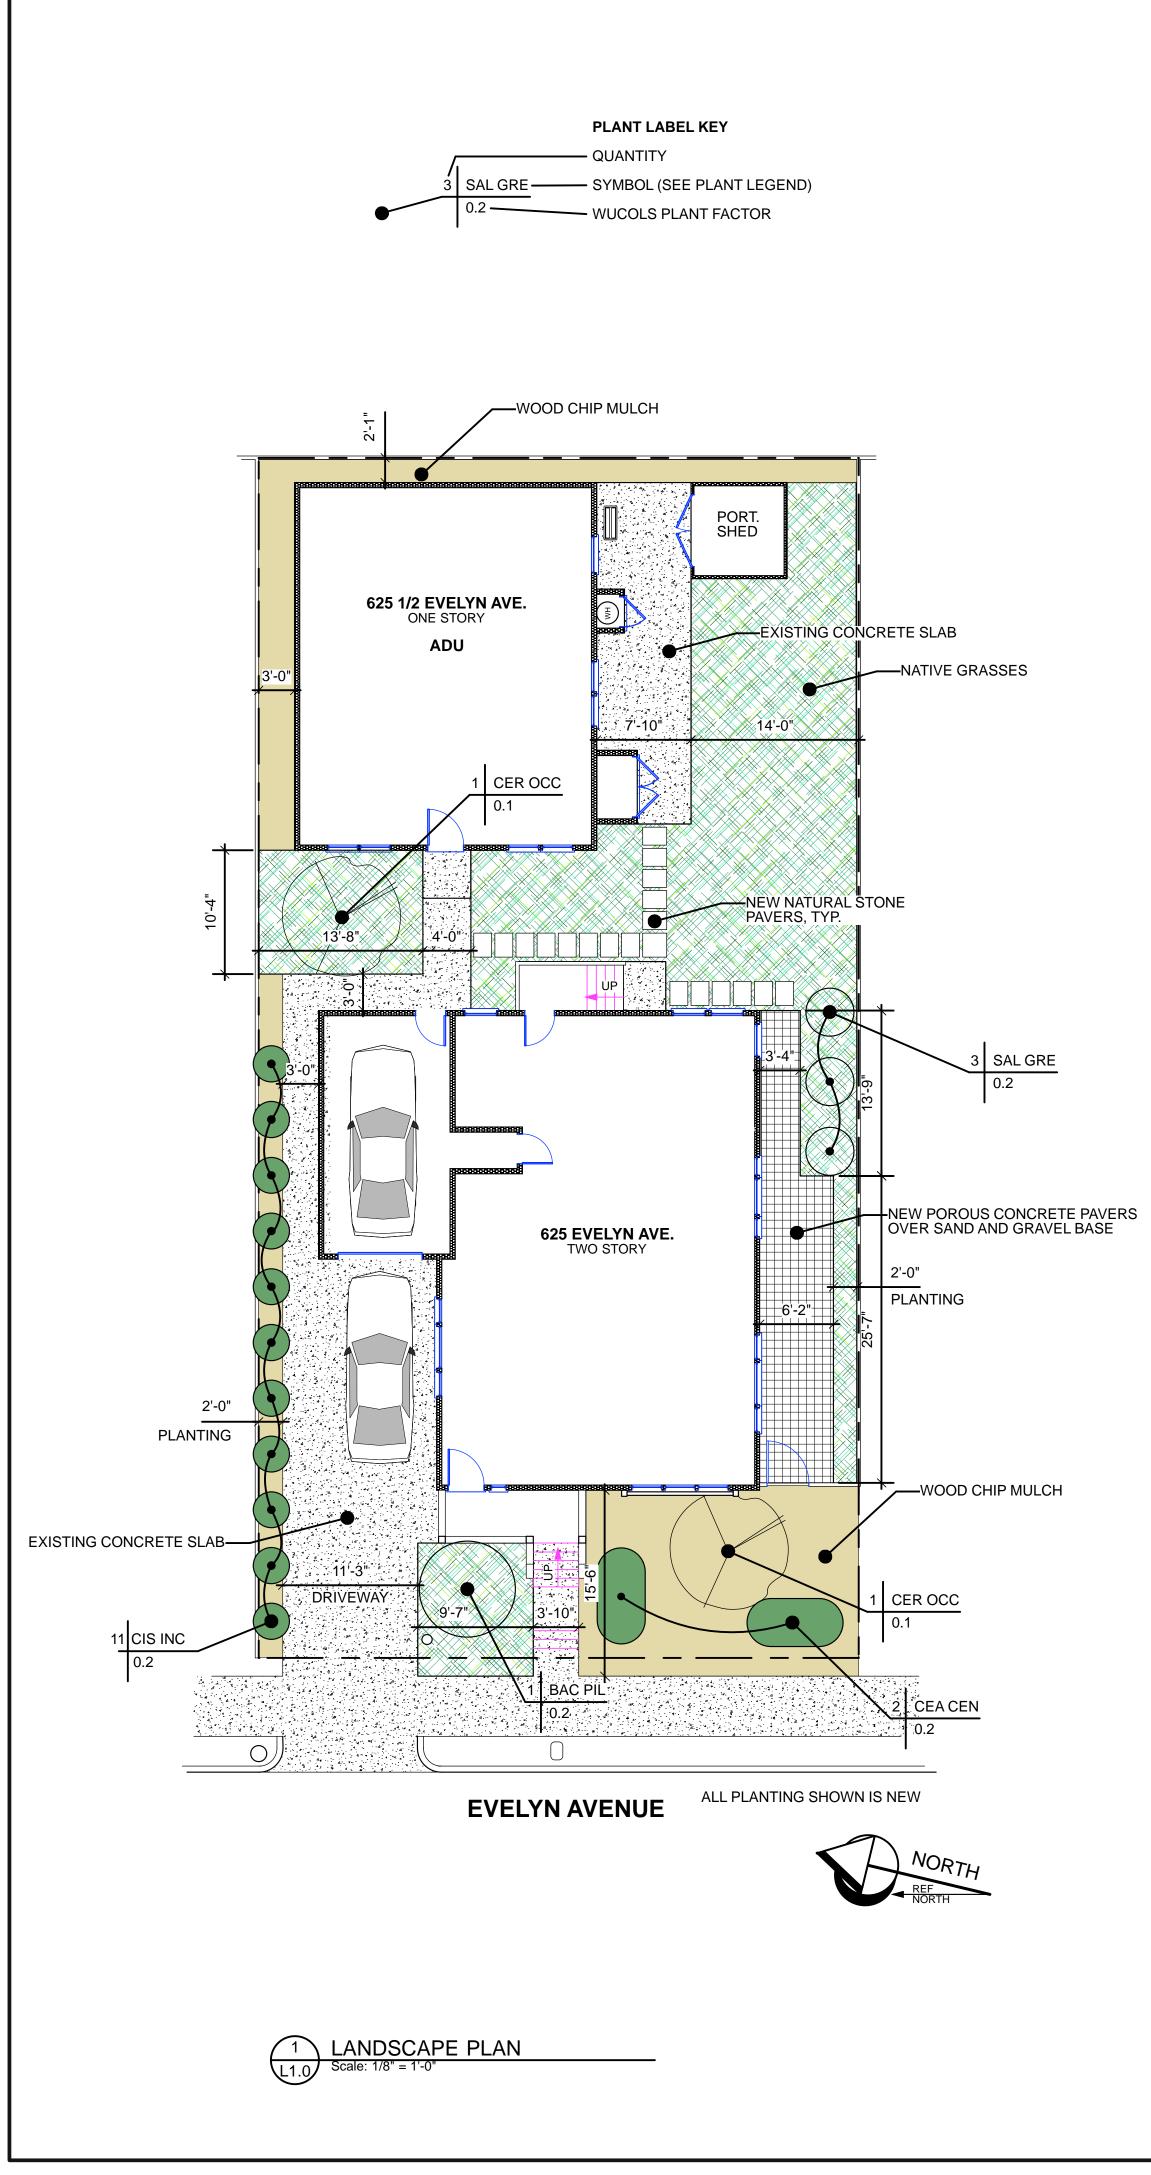

ALL PLANTING SHOWN IS NEW

PLANT LEGEND							
SYMBOL	BOTANICAL NAME	COMMON NAME	QUANTITY	SIZE	NOTES	WUCOLS	INVASIVE
Trees CER OCC	Cercis occidentalis	Western Redbud	1	24" box		Very Low	
Shrubs CIS INC SAL GRE	Cistus incanus Salvia greggii	Pink Rockrose Autumn Sage	4 3	1 gal. 1 gal.		Low Low	N N
Ground-cover BAC PIL CEA CEN	Baccharis pilularis "Twin Peaks" Ceanothus "Centennial"	Dwarf Coyote Bush Centennial Ceanothus	5 3	1 gal. 1 gal.		Low Low	N N

From Water Use Classification of Landscape Species (WUCOLS) published by the University of California Cooperative Extension and California Department of Water Resources (DWR) or other sources approved by DWR.

Plant Factors:

Very low water use = 0 to 0.1 Low water use = 0.1 to 0.4Moderate water use = 0.4 to 0.6High water use = 0.6 to 1.0

Planting Notes 1)Turf is limited to 25 percent of the total irrigated area and not planted on areas sloping more than 25 percent. 2)Plantings must be grouped into hydrozones based on microclimate, soil type, plant type, and water use classification (see wucols: www.ucnr.edu/sites/wucols/).

Irrigation
3) Precipitation rates must be uniform across each zone.
4) Emitters must be fixed rate and of the same type within a zone. no variable or adjustable flow rate emitters are allowed. mixing emitters within a zone is not allowed.

5) Overhead spray is not allowed in areas less than ten feet across in any dimension.6) Overhead spray nozzels must be set back a minimum of two feet from adjacent impervious surfaces.

Compost 7) Incorporate compost at a rate of four (4) cubic yards per 1,000 square feet into the top six (6) inches of soil or compost per horiticultural soil report recommendations.

Mulch 8) Apply organic mulch to a minimum depth of three (3) inches on all exposed soil in the planted area except where contraindicated.

HARTIGAN

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JOB:	20185	DATE:	7/1/2024
SCAL	E: As Noted		
No.	Description		Date
	DESIGN REVIEW		
SHEE	T TITLE:		
ΙΛΝ		NI	

L1.0

LANDSCAPE PLAN