APPLICABLE CODES

All work shall be done in accordance with the requirements of governing local Building, Fire and Health codes.

2022 BUILDING STANDARDS ADMINISTRATIVE CODE, PART 1, TITLE 24 C.C.R

2022 CALIFORNIA BUILDING CODE (CBC), PART 2 TITLE 24 C.C.R.

2022 CALIFORNIA RESIDENTIAL CODE (CRC), PART 2.5 TITLE 24 C.C.R.

2022 CALIFORNIA ELECTRICAL CODE (CEC), PART 3, TITLE 24 C.C.R.

2022 CALIFORNIA MECHANICAL CODE (CMC), PART 9, TITLE 24 C.C.R. 2022 CALIFORNIA PLUMBING CODE (CPC), PART 5 TITLE 24 C.C.R.

2022 CALIFORNIA FIRE CODE (CFC), PART 9, TITILE 24 C.C.R.

2022 CALIFORNIA GREEN BUILDING CODE (CFC), PART 11, TITILE 24 C.C.R. 2022 CALIFORNIA REFERENCED STANDARDS CODE, PART 12, TITLE 24 C.C.R. TITLE 19 C.C.R.,

PUBLIC SAFETY STATE FIRE MARSHAL REGULATIONS.

2022 CALIFORNIA ENERGY CODE (CEnC), PART 6, TITILE 24 C.C.R.

NFPA 72 - NATIONAL FIRE ALARM CODES (CALIFORNIA AMENDED) NFPA 241 - SAFEGUARDING CONSTRUCTION, ALTERATION, AND DEMOLITION OPERATIONS

COUNTY OF SANTA CLARA MUNICIPAL CODE

1. Unless otherwise noted, the above codes and regulations refer to the latest edition revision in force on the date of the contract.

2. All information relating to existing construction is given as being the best information available. The contractor shall verify all existing conditions, dimensions and building datum at the job site. Any discrepancies requiring modification to the Construction Documents shall be reported to the Architect immediately. No deviations from the documents shall be made by the contractor without consent from the project Designer, Architect, Engineer or Person or Agency responsible for the portion of the design in question.

GENERAL BUILDING NOTES:

- A. All dimensions are to the face of the stud unless otherwise noted.
- B. All swinging doors and windows leading to unconditioned spaces shall be fully weather stripped. All manufactured windows and sliding doors shall be certified and labeled to meet current ANSI or infiltration standards.
- C. Shower heads and faucets shall be equipped with flow restriction devices as outlined
- in the appliance efficiency standards and shall be certified by the C.E.C. D. All insulation shall be certified and labeled as complying with the California Energy Commission's "Standards for Insulating Materials". Surface burning characteristics of insulating materials with facings and membranes intended for exposed applications shall not exceed the following values: flame spread 25, smoke developed 450
- E. Lamps used in luminaries for general lighting in kitchen and bathrooms shall have an efficiency of not less than 40 lumens per watt. Fluorescent ballasts to be low energy type and certified by the C.E.C
- F. Ducts shall be installed and sealed per CMC sections 603, 604, and 605. Ducts shall be insulated per CMC section 604. Exhaust fans shall have back draft dampers per CMC
- G. Address numbers and letters shall be illuminated, installed on a contrasting background, and be plainly visible from the street or road fronting the property, and sized as follows: New and existing buildings shall be provided with approved address numbers or letters. Each character shall be not less than 4 inches (102 mm) in height and not less than 0.5 inches (12.7 mm) in width.
- H. When a residential fire sprinkler system is required it shall be installed in accordance with NFPA 13D and State and Local requirements

NOTES FOR REMODELING AND ADDITIONS

- A. Existing construction shown on drawings as well as these drawings are based upon information obtained from existing drawings and / or field measurements.
- B. Contractor shall verify all existing field conditions prior to starting construction. C. If existing structural members are encountered during demolition which are not as to be removed, these shall be brought to the attention of the Architect or Engineer
- immediately prior to any further demolition. D. Remove and relocate (e) mechanical, electrical, plumbing and other items not indicated on plans, as required for construction of remodeled area. All areas to be patched and
- repaired to match existing. E. The contractor shall safely shore existing construction as required for installation of new work.
- All ideas and designs represented and indicated on these drawings are the property of Mayberry Workshop, and are created solely for this specific project. They shall not be used, copied, modified, assigned to another party reproduced for any purpose whatsoever without the written permission of Mayberry Workshop. In the event of unauthorized use of these plans by any third party, Mayberry Workshop shall be held harmless for an claim arising from unauthorized use.

DEFERRED SUBMITTALS:

All deferred submittals shall first be submitted to the responsible registered design professional, who shall review them and forward them to the building official with a notation indicating that the deferred submittal documents have been reviewed and have been found to be in general conformance with the design of the building. The deferred submittal items shall not be installed until the deferred submittal documents have been approved by the building official.

DEFFERED ITEMS IN THIS PROJECT:

1. PV SOLAR PANELS





SHEET INDEX

NUMBER	SHEET NAME		250121 Design Review	250402 Design Review Comments
	SHEET ISSUED AND REVISED	×	0121	250402 Comme
	SHEET ISSUED WITHOUT REVISION		25	25 Cc
G0.2	CURRENT PHOTOS AND STREET ELEVATIONS		X	
A0.1	SITE SURVEY		\boxtimes	
A0.3	LOT COVERAGE AND FAR DIAGRAMS		×	
A1.1	DEMOLITION PLANS AND ELEVATIONS	·	×	
A2.2	ROOF PLAN		×	
A3.3	SECTIONS		×	
A5.1	DOOR / WINDOW SCHEDULES		×	
G0.1	COVER SHEET		\boxtimes	×
A0.2	SITE PLAN		×	×
A2.1	FLOOR PLAN		×	X
A3.1	EXISTING ELEVATIONS	,		×
A3.2	PROPOSED ELEVATIONS		×	×

PROJECT CODE INFORMATION

A 246 Sq. Ft. SINGLE STORY ADDITION ATTACHED TO EXISTING HOUSE

PROJECT ADDRESS: 1020 KEY ROUTE BLVD, ALBANY, CA 94706

APN#: 065-2650-077-01

ZONING: OCCUPANCY: **CONSTRUCTION TYPE:** TYPE V - B

MAIN HOUSE SPRINKLED: NO FLOOD ZONE: **HISTORICAL CATEGORY:** NONE **GARAGE PLACEMENT:** ATTACHED

LOT AREA: 3520 Sq. Ft.

EXISTING HOME AREA

PROJECT DESCRIPTION:

EXISTING HOME FLOOR AREA: 959 Sq Ft **EXISTING GARAGE AREA:** 0 Sq Ft

SITE REGULATIONS - ZONE: R-1


SETBACKS			
		PROPOSED	
	EXISTING	(with ADDITIONS)	<u>REQUIREMENT</u>
FRONT	6	6	15' MIN
LEFT SIDE	5	5	5'
RIGHT SIDE	4	4	5'
REAR	20	5	20' MIN
MAXIMUM HEIGHT	17'-9"	10'-9"	28' MAX

MAYBERRY WORKSHOP ARCHITECTURE 231 D ST, STE A **DAVIS, CA 95616 WWW.MWORK.SHOP**

Revision

DESIGN REVIEW COMMENTS

VICINITY MAP

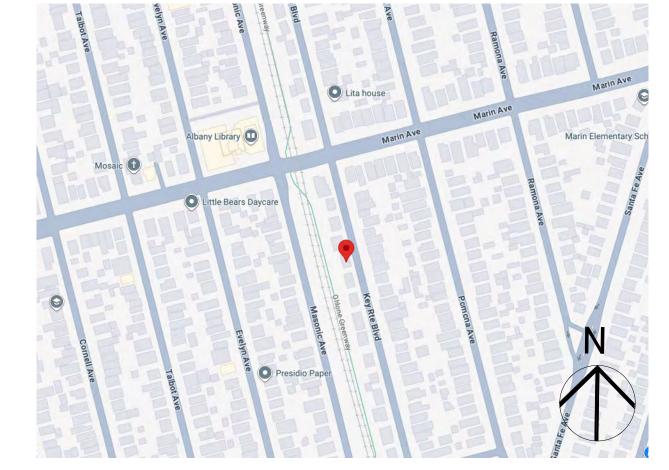


KEY ROUTE ADDITION

1020 Key Route Blvd, Albany, CA 94706

PROJECT TEAM

Client Haley & Bob Ni 1020 Key Route Blvd Albany, CA 94706 E: hbudigan@gmail.com P: (206)371-0721

ARCHITECT MAYBERRY WORKSHOP ARCH 231 D ST, STE A **DAVIS, CA 95616** Contact: Adam Mayberry E: adam@mayberryworkshop.com P: 408.582.4567

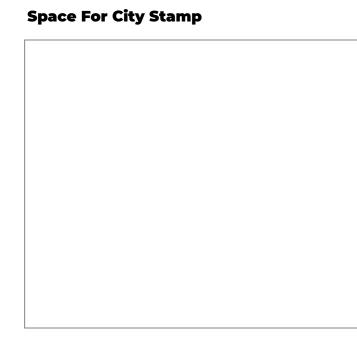

Project: **KEY ROUTE ADDITION**

1020 Key Route Blvd Albany, CA 94706


Issue Date Drawn Approved

Scale Sheet Title: **COVER SHEET**

G0.1

EXISTING NEIGHBOR - SOUTH (1024 Key Route Blvd)

SCALE: 1' = 1'-0"

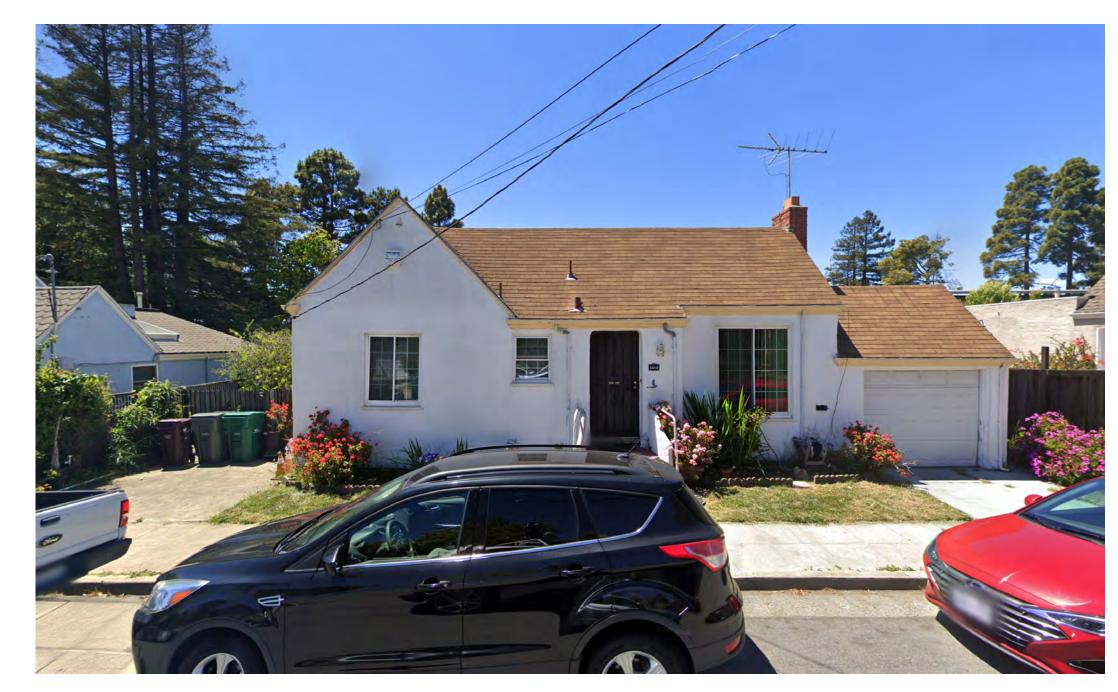


3 EXISTING NEIGHBOR - NORTH (1016 Key Route Blvd)

SCALE: 1' = 1'-0"



EXISTING HOME - FRONTSCALE: 1' = 1'-0"

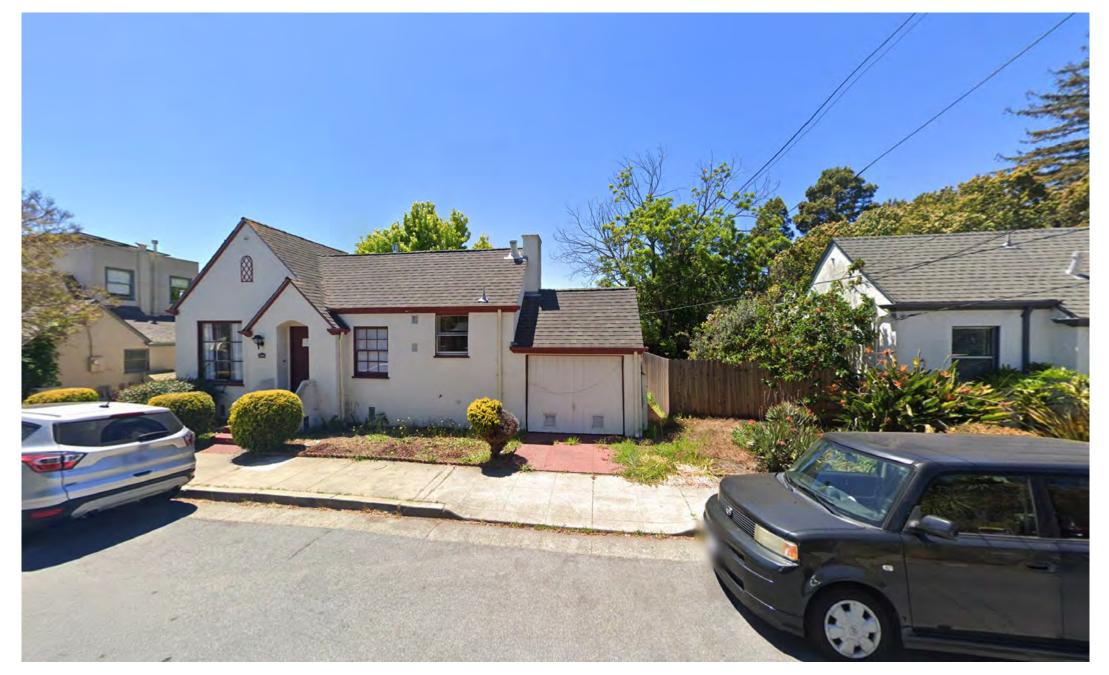

EXISTING NEIGHBOR - SOUTH (1028 Key Route Blvd)

SCALE: 1' = 1'-0"



EXISTING NEIGHBOR - NORTH (1012 Key Route Blvd)

SCALE: 1' = 1'-0"



6 EXISTING HOME - BACKYARD

SCALE: 1' = 1'-0"

Space For City Stamp



231 D ST, STE A DAVIS, CA 95616 WWW.MWORK.SHOP


City Approvals:


Project: **KEY ROUTE ADDITION**

1020 Key Route Blvd

Sheet Title:
CURRENT PHOTOS AND STREET **ELEVATIONS**

G0.2

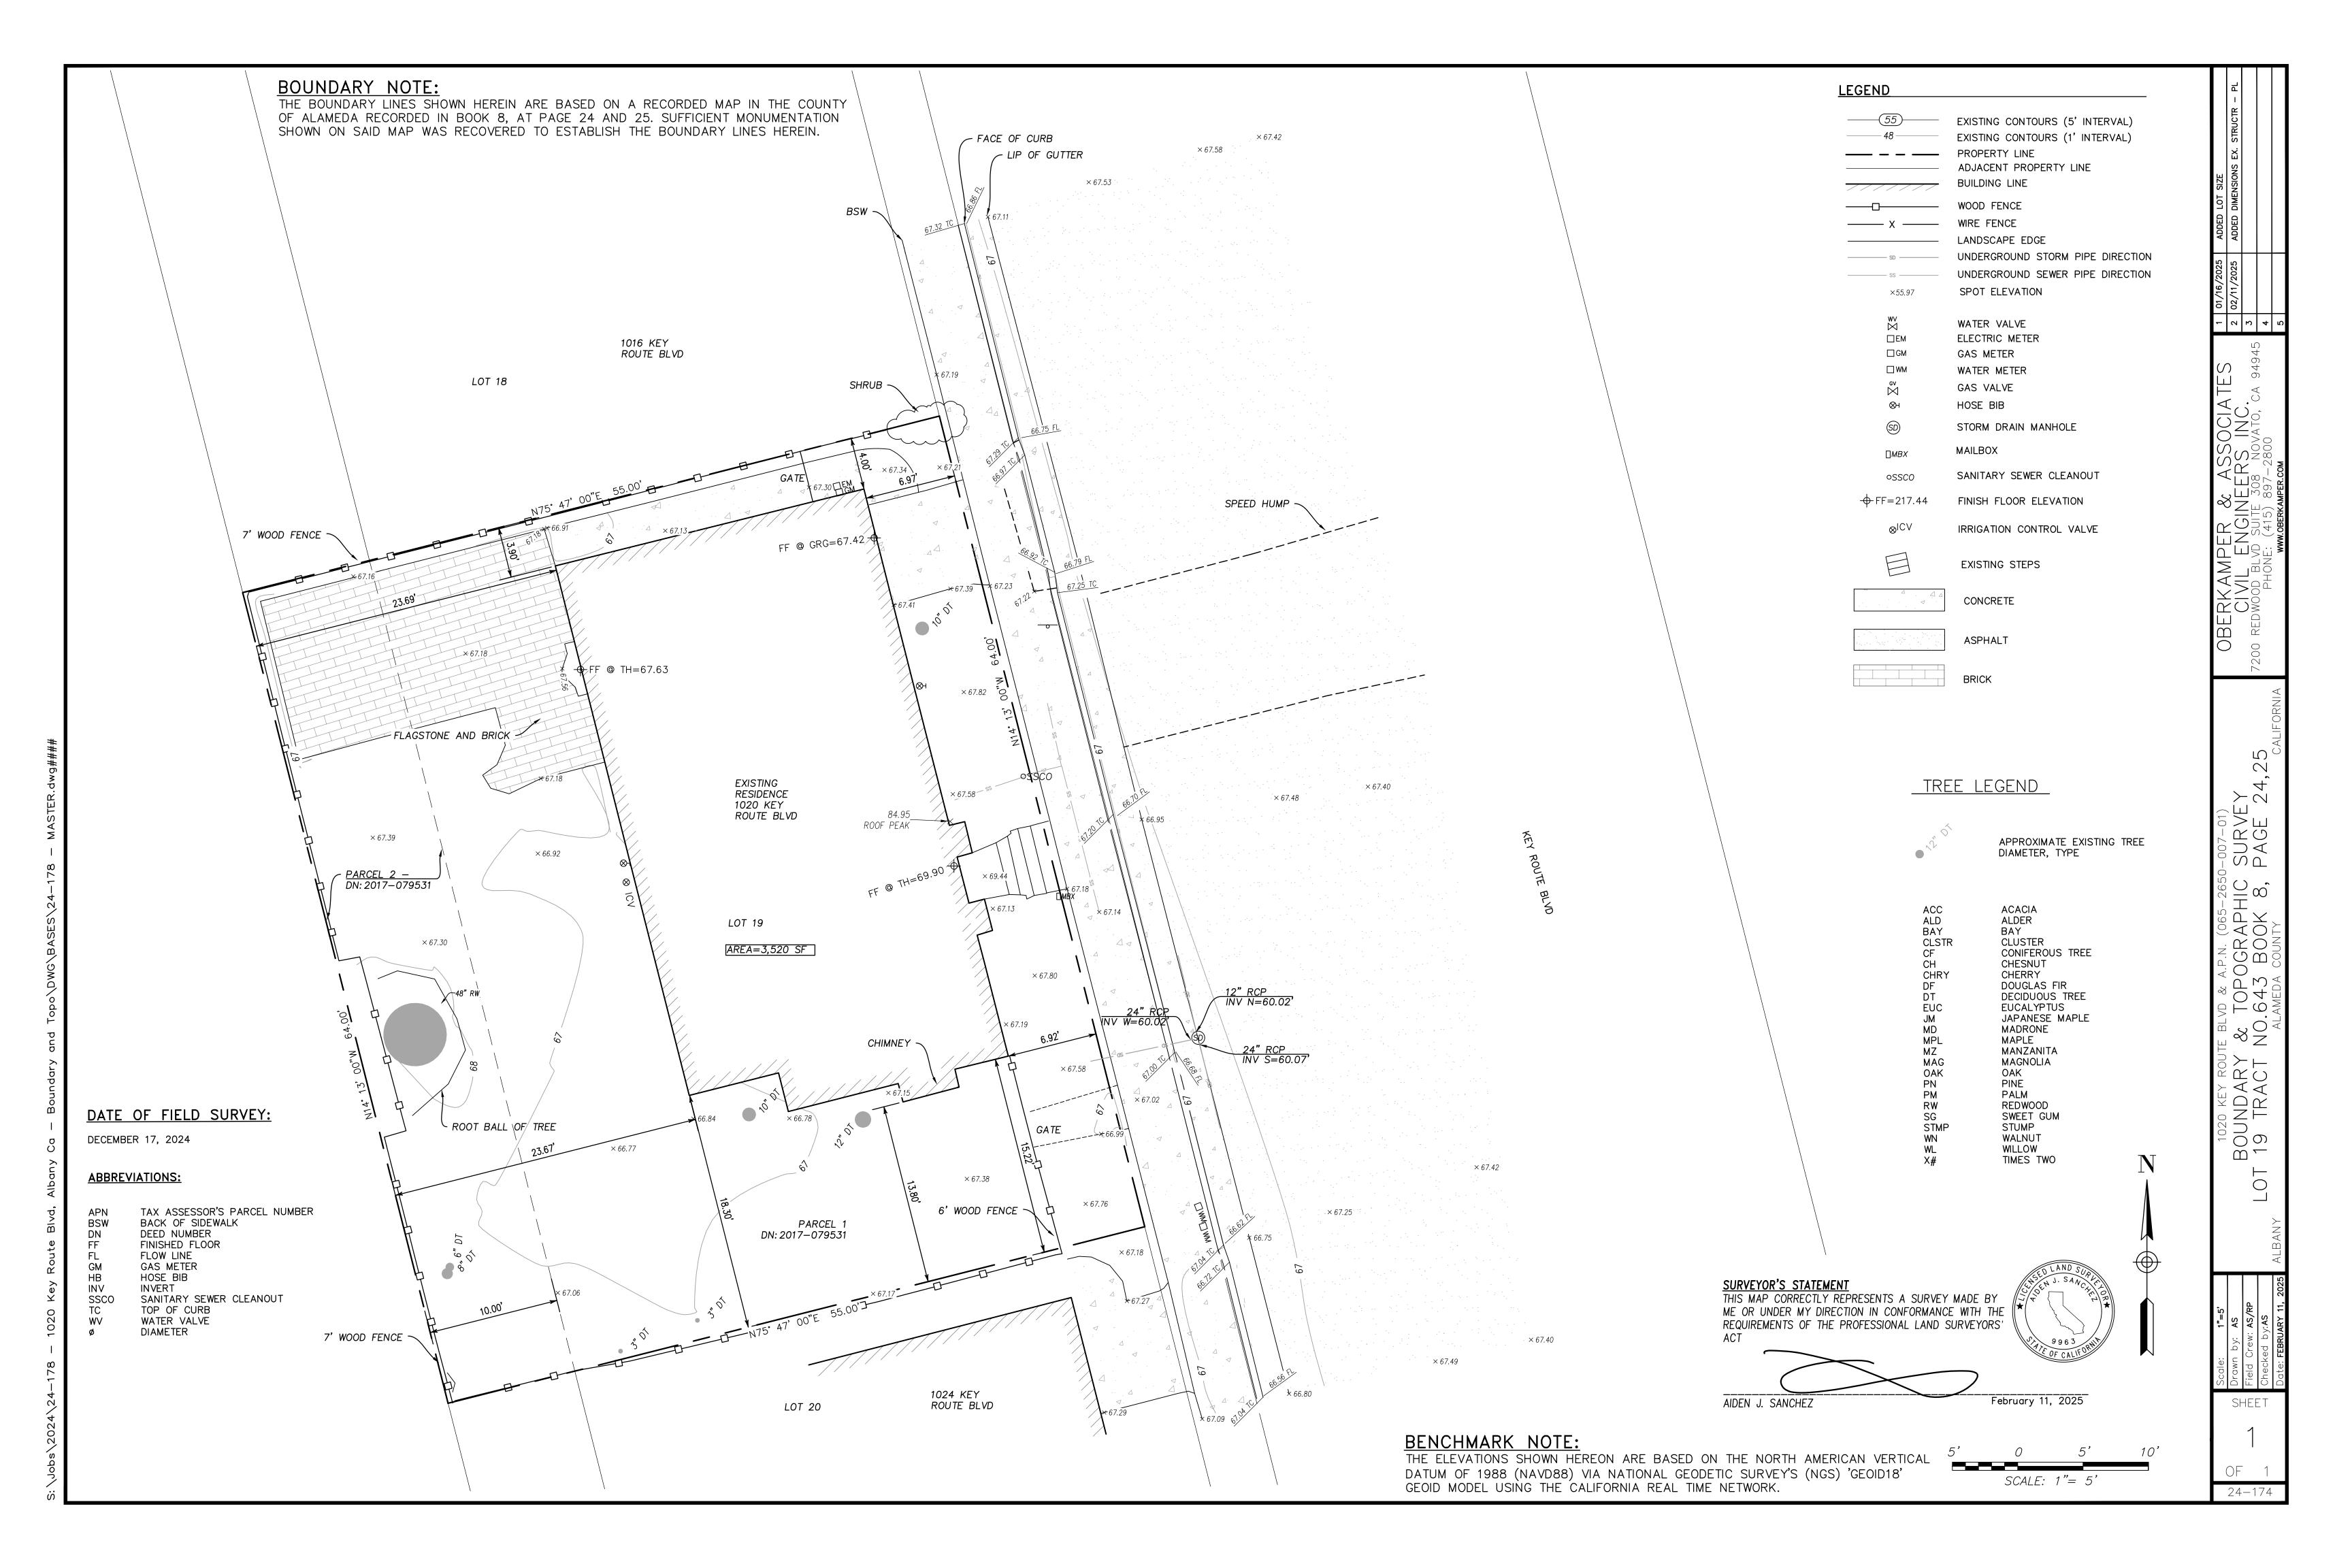

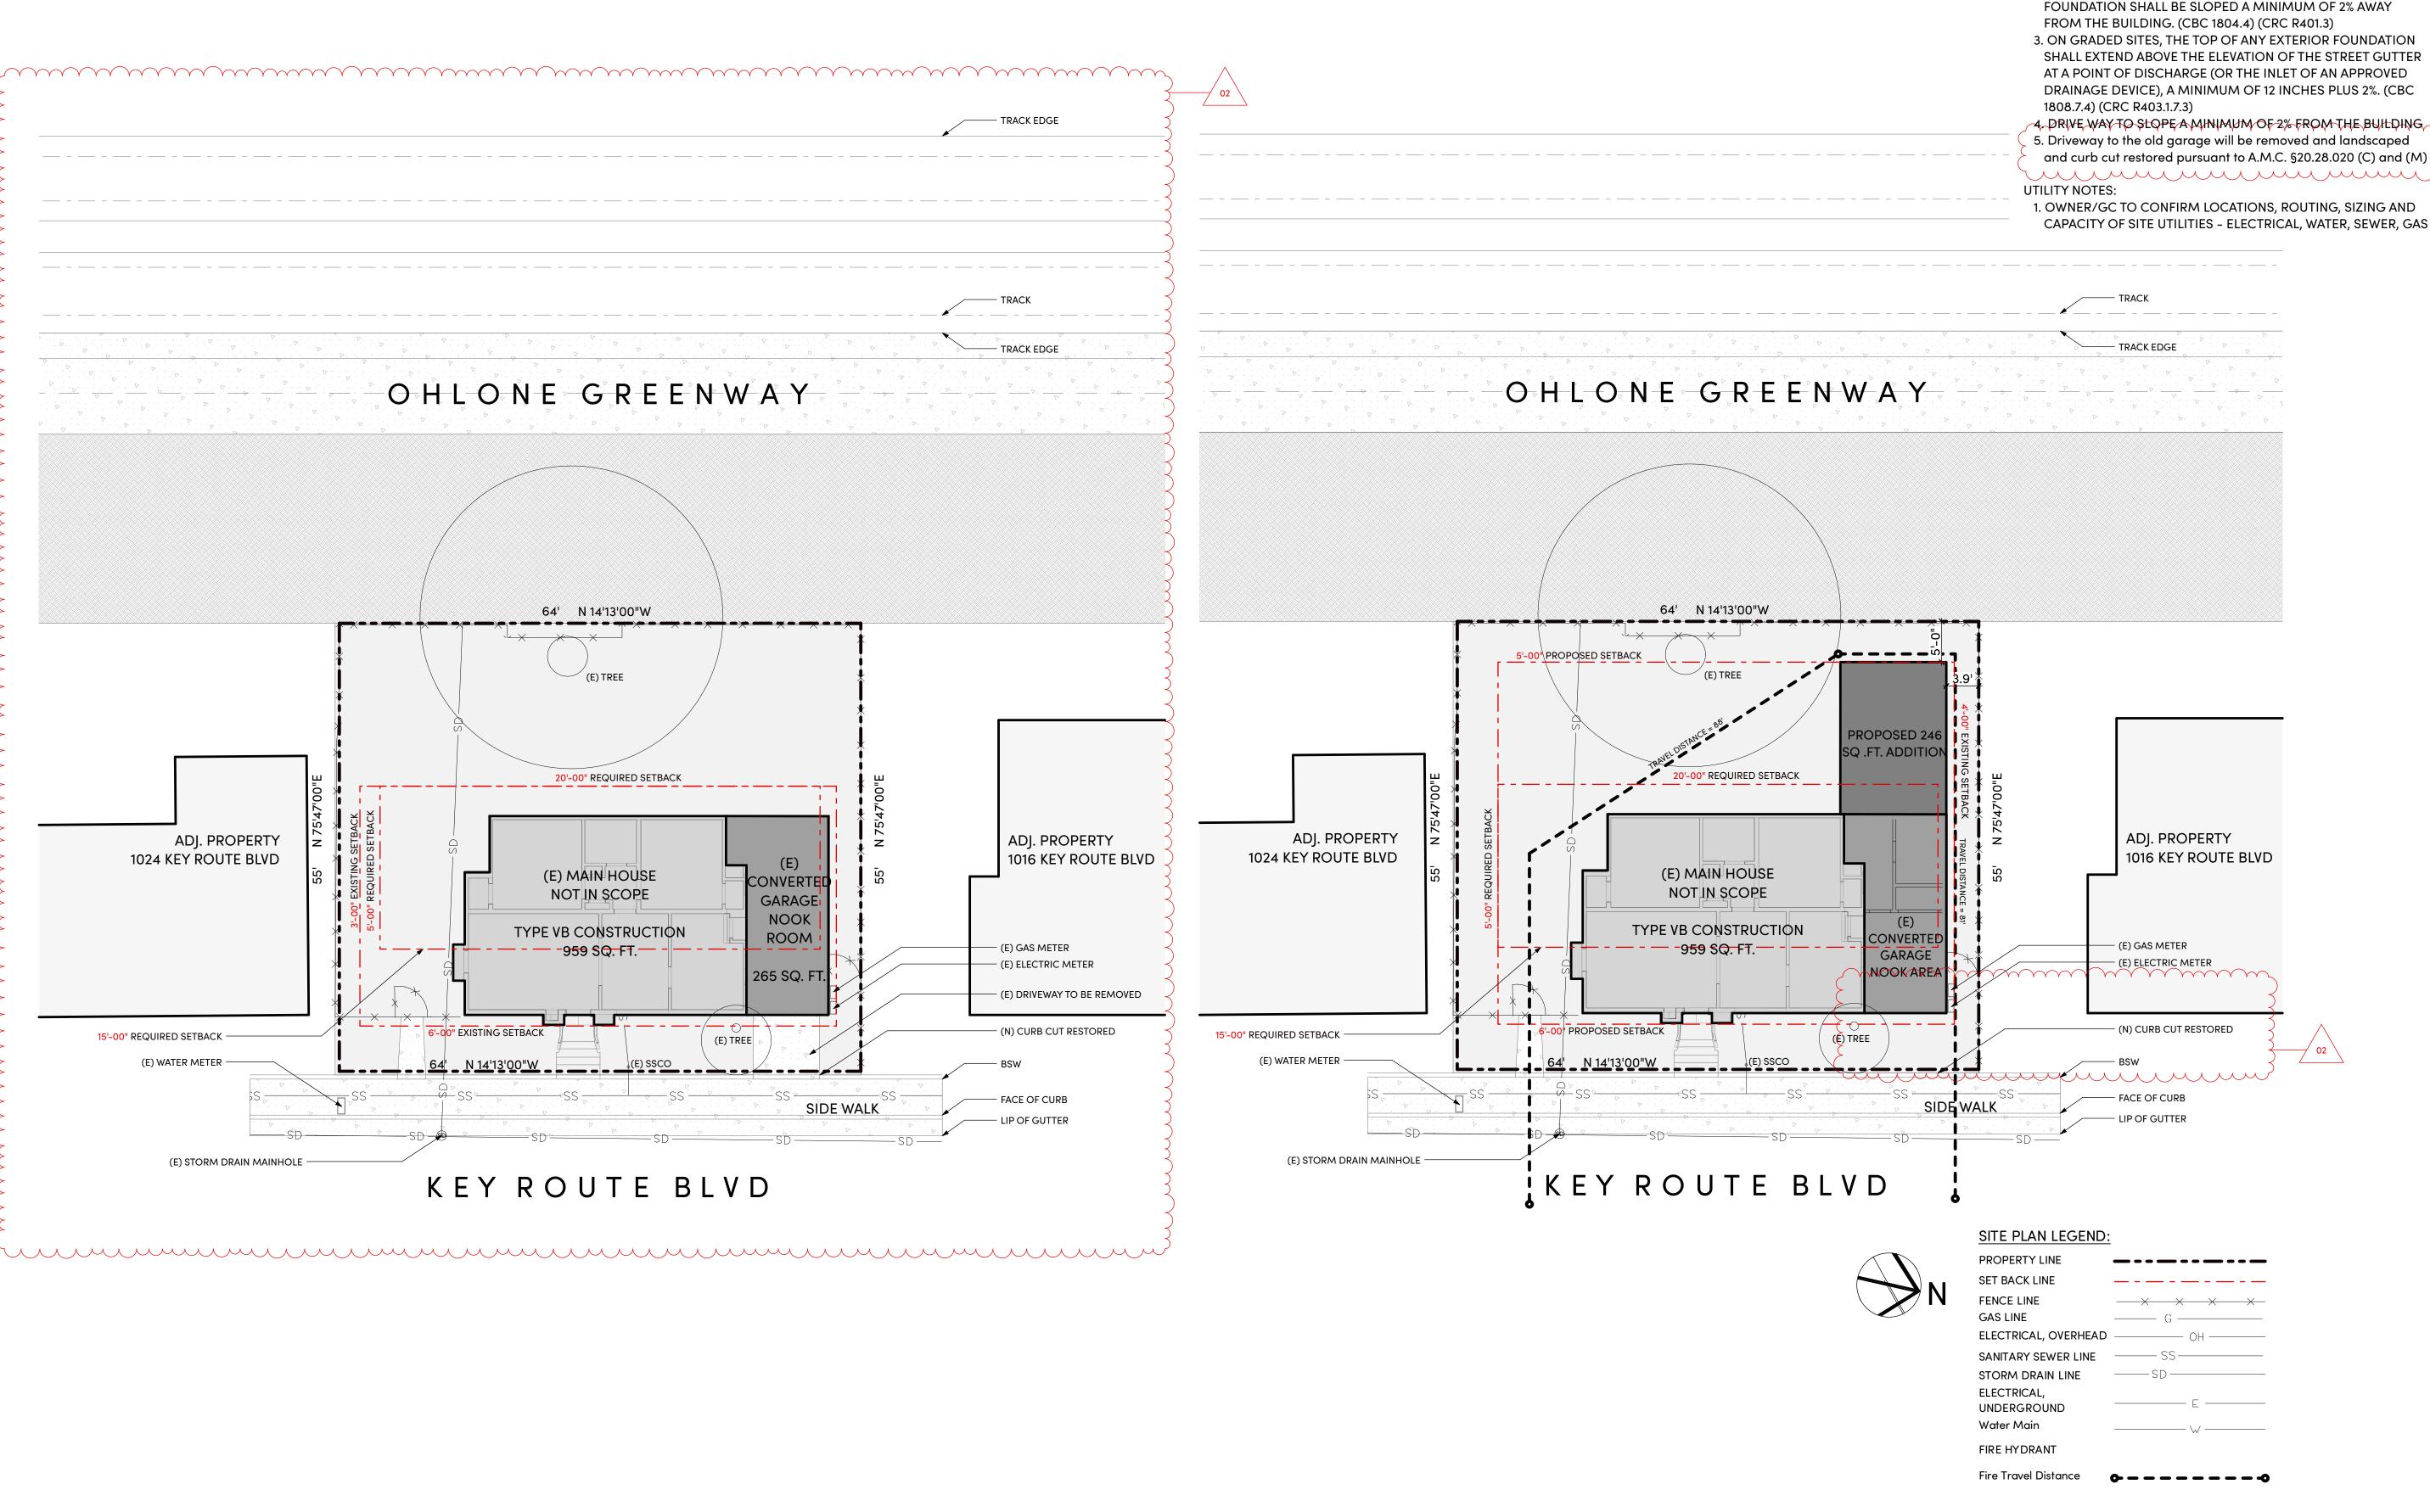

PROPOSED SITE PLAN

SCALE: 1" = 10'

EXISTING SITE PLAN

SCALE: 1" = 10'

SITE PLAN NOTES

SEWER CLEAN-OUTS SHALL BE INSTALLED AS FOLLOWS:

1. EVERY 100 FEET OF DEVELOPMENT DRAINAGE LINES 2. AT EACH AGGREGATE HORIZONTAL CHANGE OF DIRECTION **EXCEEDING 135 DEGREES**

GRADING NOTES:

1. FINISH GRADE AROUND THE STRUCTURE SHALL SLOPE AWAY FROM THE FOUNDATION A MINIMUM OF 5% FOR A MINIMUM OF 10 FEET. (CBC 1804.4) (CRC R401.3)

2. IMPERVIOUS SURFACES WITHIN 10-FT OF THE BUILDING FOUNDATION SHALL BE SLOPED A MINIMUM OF 2% AWAY

SHALL EXTEND ABOVE THE ELEVATION OF THE STREET GUTTER AT A POINT OF DISCHARGE (OR THE INLET OF AN APPROVED DRAINAGE DEVICE), A MINIMUM OF 12 INCHES PLUS 2%. (CBC

5. Driveway to the old garage will be removed and landscaped

and curb cut restored pursuant to A.M.C. §20.28.020 (C) and (M)

CAPACITY OF SITE UTILITIES - ELECTRICAL, WATER, SEWER, GAS

ARCHITECTURE

Space For City Stamp

231 D ST, STE A **DAVIS, CA 95616 WWW.MWORK.SHOP**

Revisio)[]	
MARK	DESCRIPTION	DATE
01	DESIGN REVIEW	
02	DESIGN REVIEW COMMENTS	



Project:

KEY ROUTE ADDITION

1020 Key Route Blvd Albany, CA 94706


Issue Date

Scale

Sheet Title: SITE PLAN


LOT COVERAGE DIAGRAM

FLOOR AREA SUMMARY

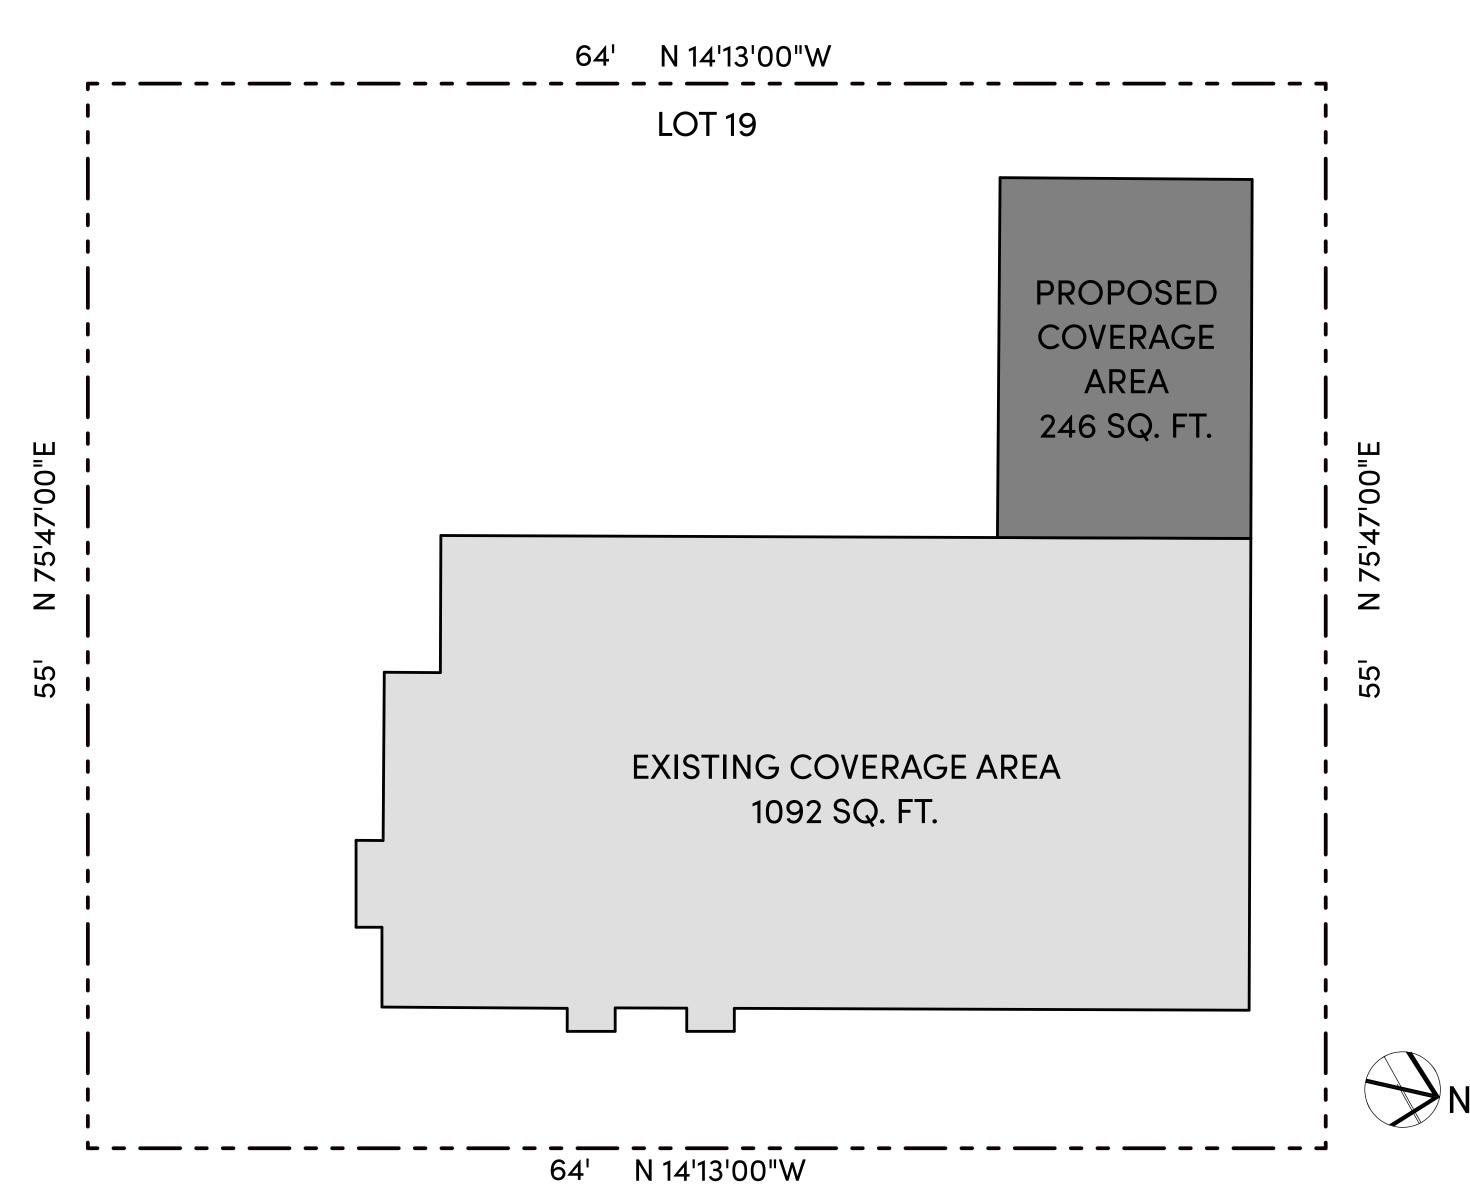

LOT COVERAGE		FAR (GROSS AREA)	
LOT AREA ALLOWED	3520 1760	EXISTING NEW PROPOSED	1092 246 1338
EXISTING NEW PROPOSED	1092 246 1338		
PERCENTAGE		PERCENTAGE	
ALLOWED EXISTING PROPOSED	50% 31% 38%	ALLOWED EXISTING PROPOSED	0.55 0.31 0.38



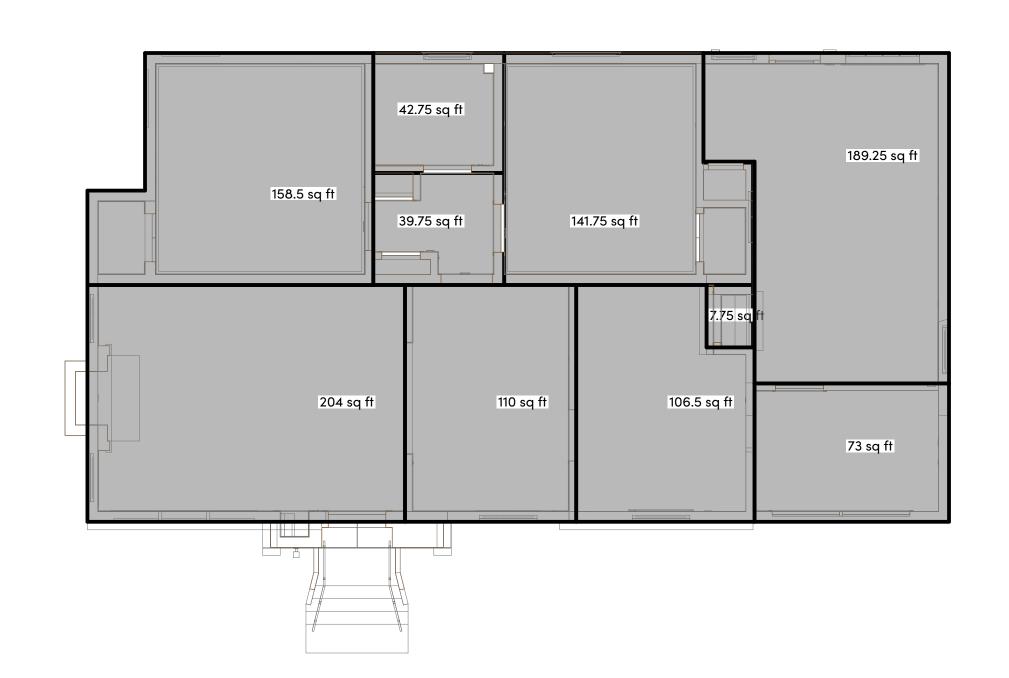

Space For City Stamp



231 D ST, STE A DAVIS, CA 95616 WWW.MWORK.SHOP



Revision

MARK	DESCRIPTION	DATE
01	DESIGN REVIEW	




Project:


KEY ROUTE ADDITION

1020 Key Route Blvd


Sheet Title: LOT COVERAGE AND FAR DIAGRAMS

A0.3

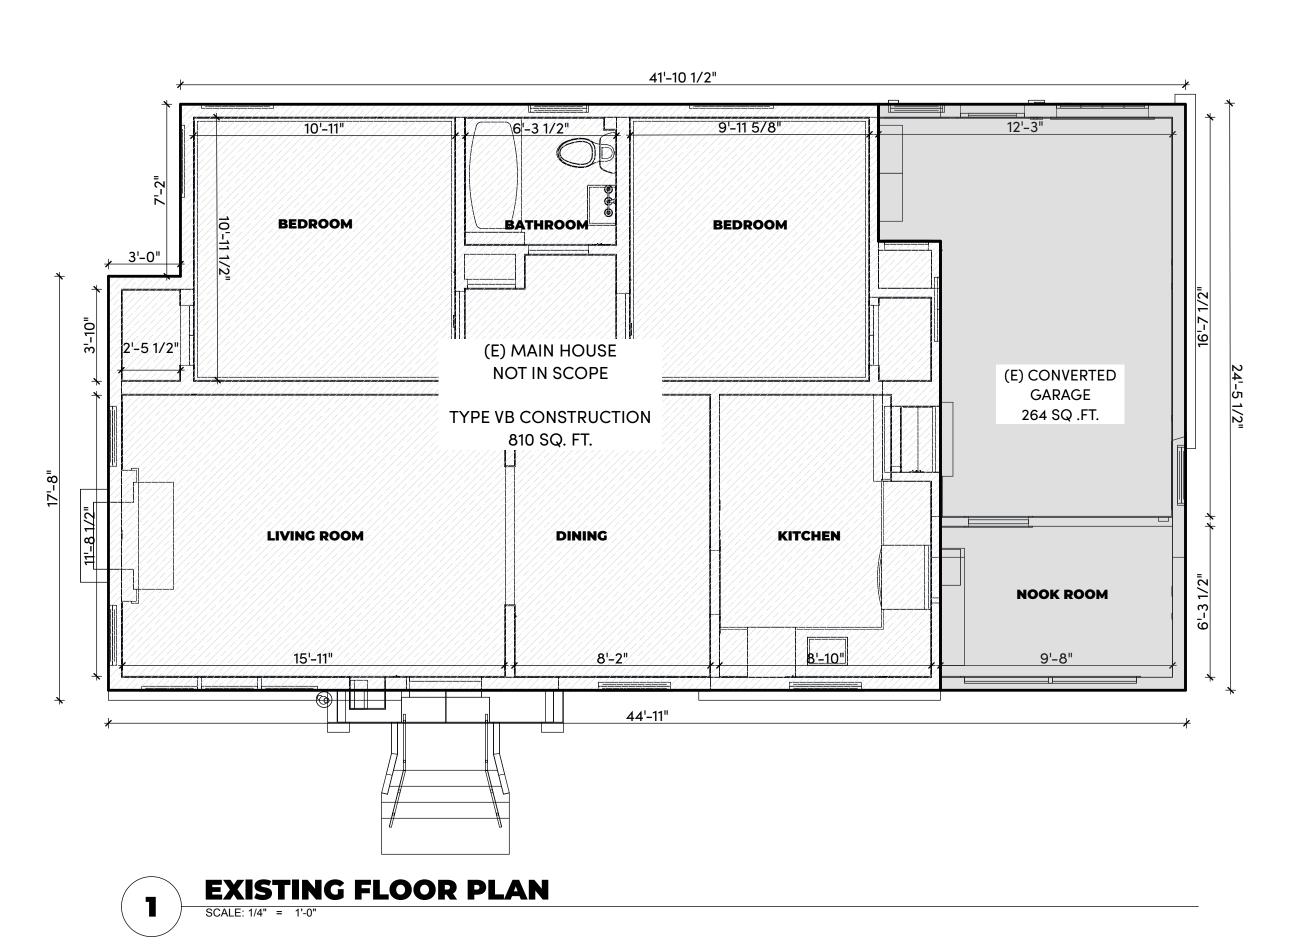

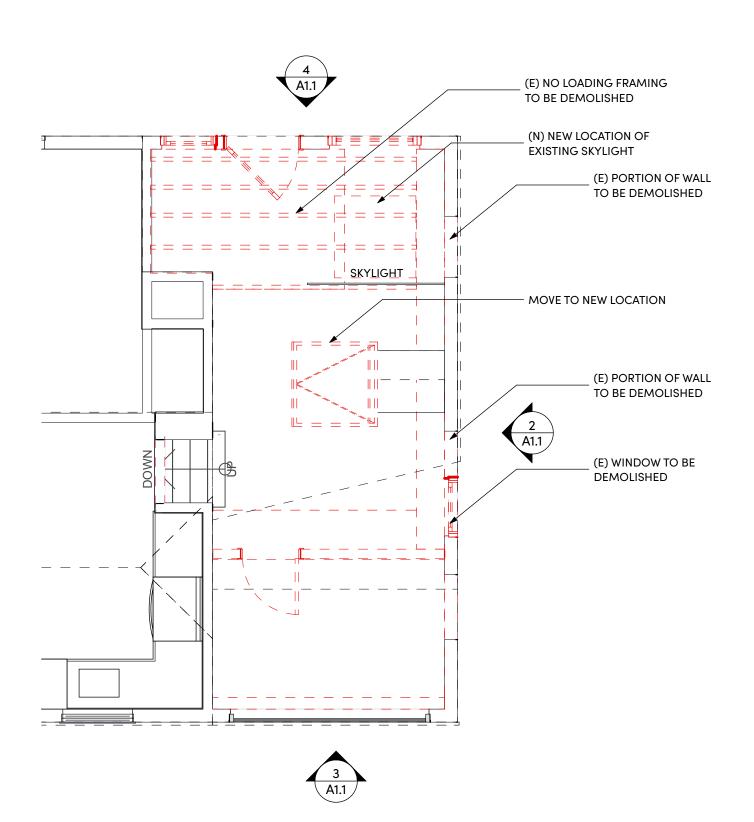




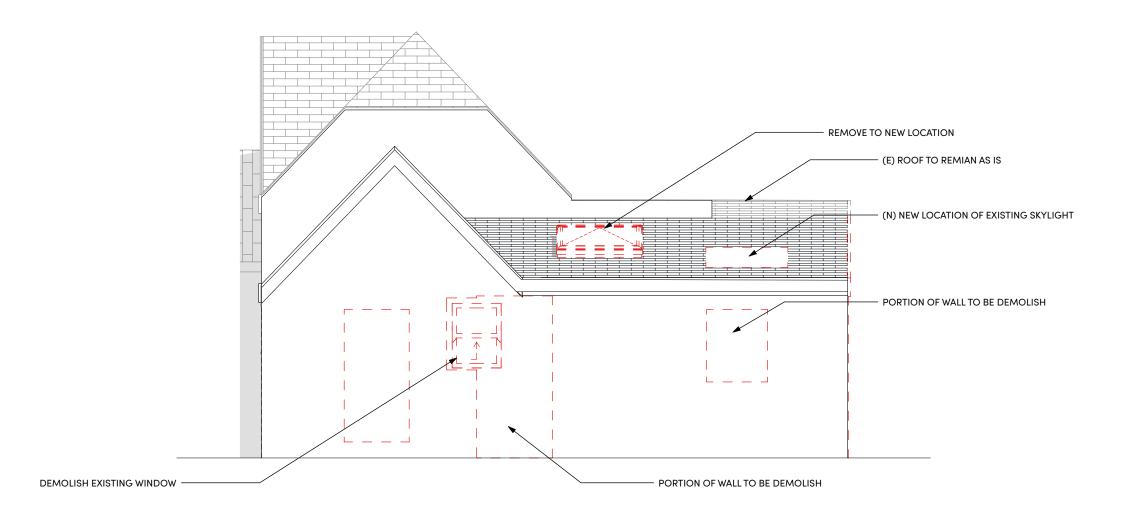


Demo Elevation - Side

SCALE: 1/4" = 1'-0"

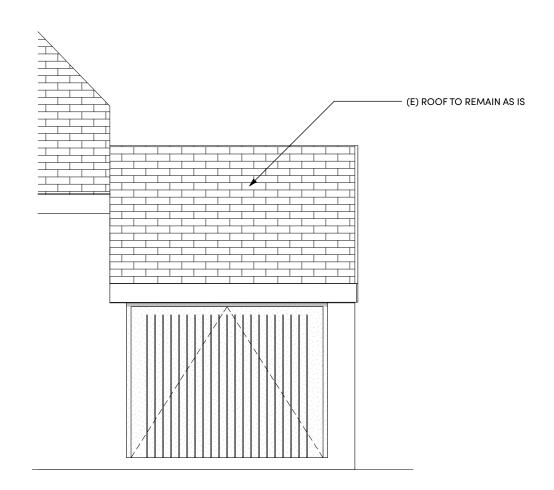

Demo Elevation - Front

SCALE: 1/4" = 1'-0"

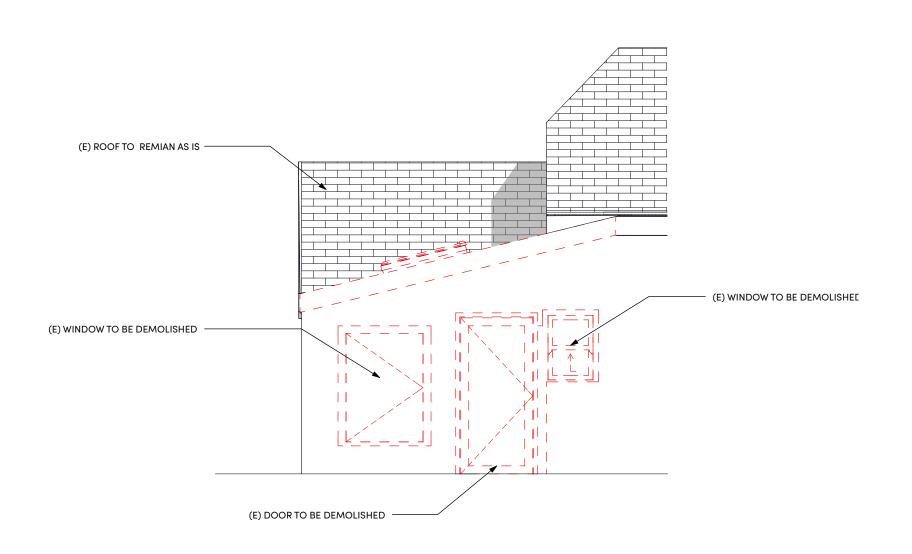

Demo Elevation - Back

SCALE: 1/4" = 1'-0"

LEGEND

WALLS TO BE REMOVED

WALLS TO REMAIN

DOORS TO BE REMOVED

WINDOWS TO BE REMOVED

NOTE

NOTE
- CONSULT STRUCTURAL ENGINEER & MAINTAIN STRUCTURAL
ADEQUACY OF THE BUILDING AT ALL TIME.

- DEMOLISH OR REMOVE ALL WALLS, FIXTURES & FITTINGS
SHOWN DASHED
- DISCONNECT ALL SERVICES PRIOR TO COMMENCING ANY

DEMOLITION WORK

- TAKE CARE TO PROTECT SURFACES THAT ARE TO REMAIN
ADJACENT TO DEMOLISHED WORK & MAKE GOOD ALL
SURFACES DAMAGED DURING DEMOLITION

- MAINTAIN REQ. AIR ENVIRON. WITH TEMP WALL OR BARRIERS & FILTERED REQ. AIR DEVICES.

- SECURE ALL TEMP BARRIES AS REQ. TO SEAL DUST & DEBRIS FROM (E) LIVING AREA

- REFER TO STRUCTURAL DWG FOR MODIFICATION TO EXISTING WALL FOR SHEAR DESIGN AND NEW POST LOCATIONS

Space For City Stamp



231 D ST, STE A DAVIS, CA 95616

WWW.MWORK.SHOP

ADDITION

1020 Key Route Blvd
Albany, CA 94706

Revision

MARK DESCRIPTION DATE

01 DESIGN REVIEW

Stamp



Project:

KEY ROUTE ADDITION

1020 Key Route Blvd Albany, CA 94706


Issue Date 4/3/25

Job Number 24-040

Drawn Approved

Sheet Title:
DEMOLITION PLANS
AND ELEVATIONS


A1.1

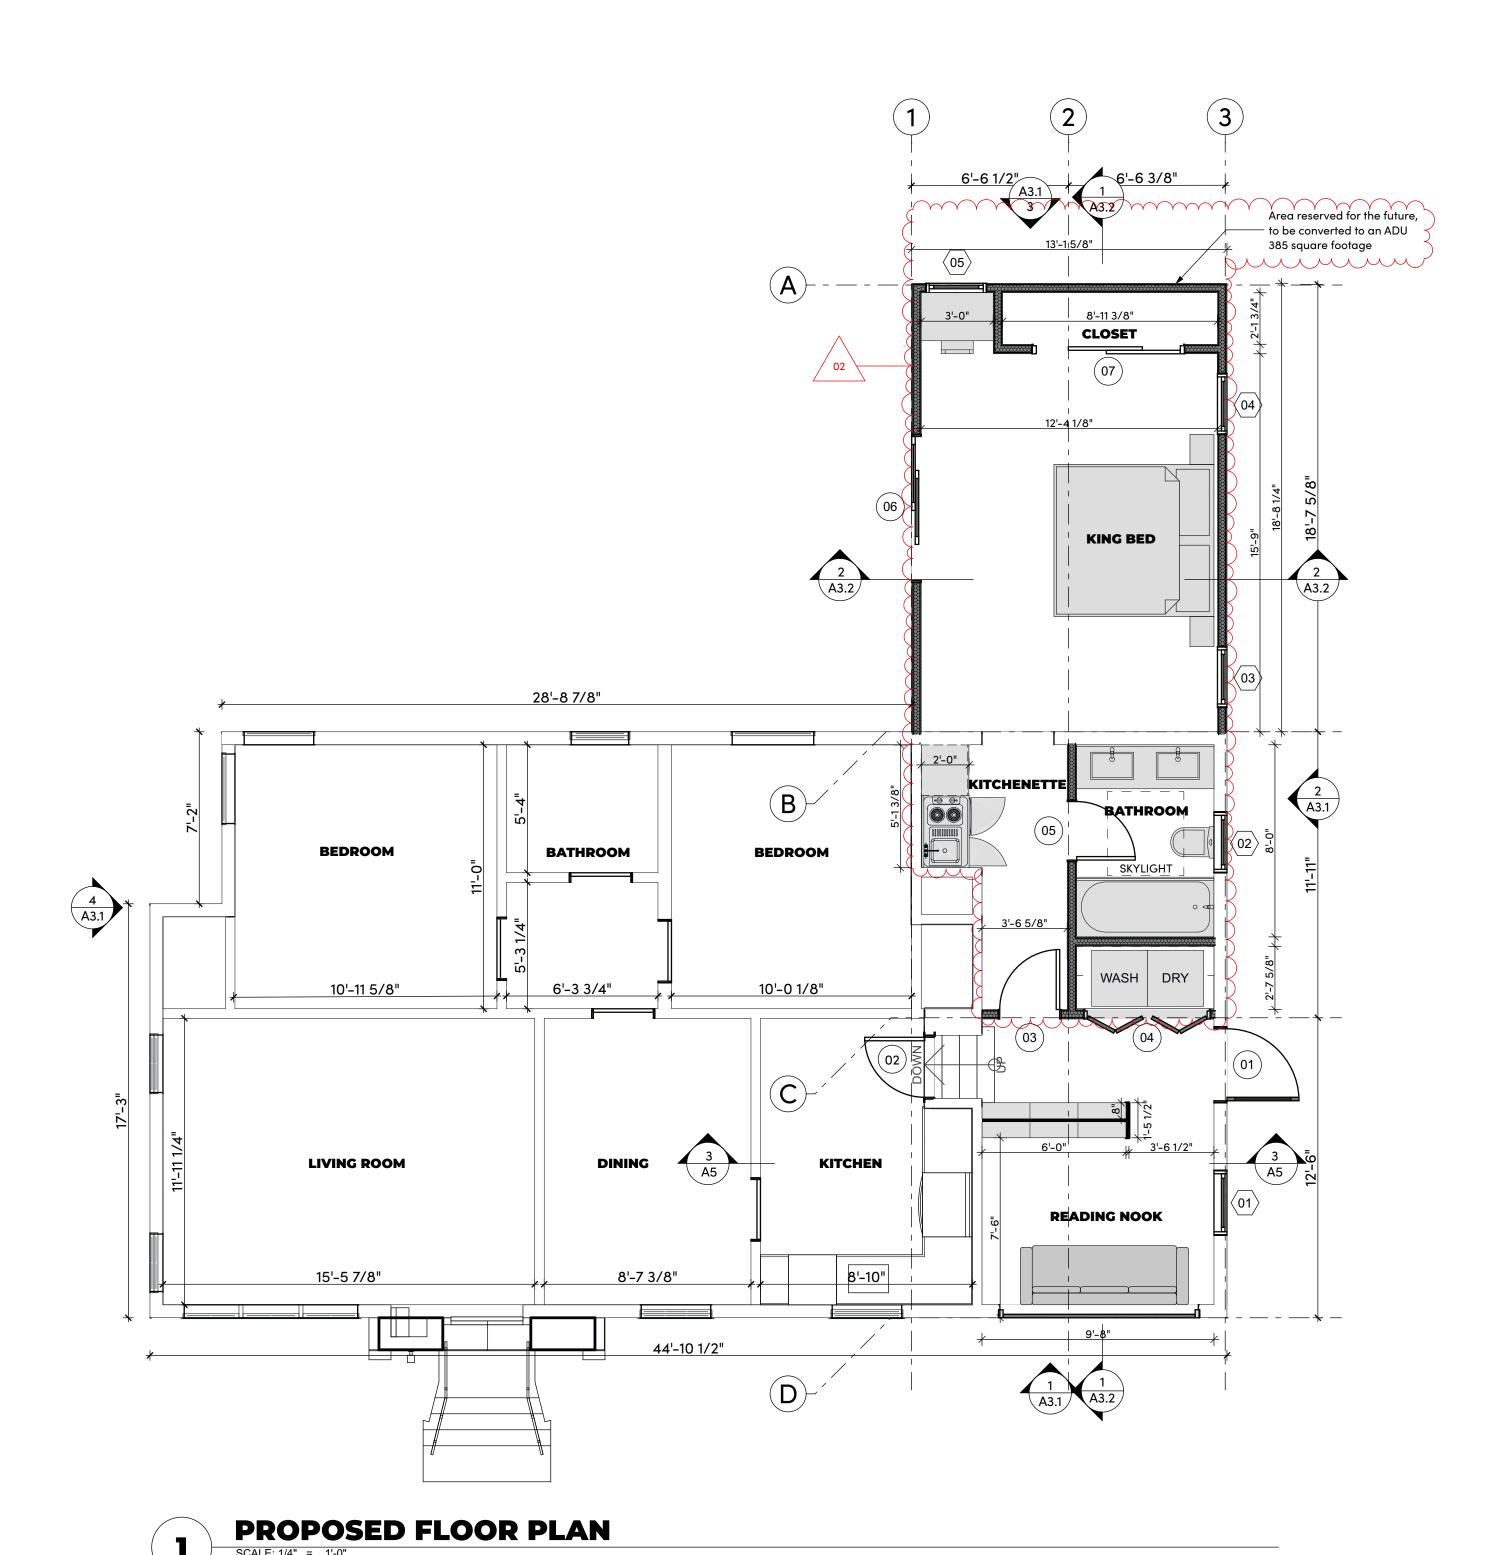

FLOOR PLAN NOTES

- 1. DO NOT SCALE DRAWINGS
- 2. SEE ELECTRICAL PLAN FOR ADDITIONAL INFORMATION
- 3. SEE STRUCTURAL PLANS FOR ADDITIONAL INFORMATION 4. COLUMN GRID DENOTED ALIGNMENT WITH OUTSIDE FACE OF
- STUD FRAMING 5. VERIFY WINDOWS, DOORS, APPLIANCES AND EQUIPMENT
- ROUGH OPENINGS WITH MANUFACTURERS PRODUCT DATA 6. ALL EXTERIOR WALL ARE WALL TYPE W6 UNLESS NOTED
- OTHERWISE
- 7. ALL INTERIOR WALLS ARE WALL TYPE W4 UNLESS NOTED OTHERWISE
- 8. 2-HOUR FIRE PROTECTED EAVES PROVIDED

GENERAL DETAILS

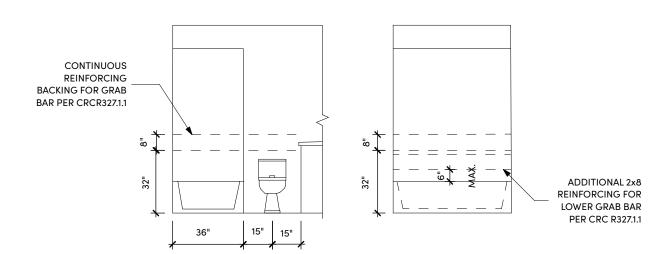


AS PER R327.1.1 Reinforcement for Grab Bars

At least one bathroom on the entry level shall be provided with reinforcement installed in accordance with this section. Where there is no bathroom on the entry level, at least one bathroom on the second or third floor of the dwelling shall comply with this section.


- 1. Reinforcement shall be solid lumber or other construction materials approved by the enforcing agency.
- 2. Reinforcement shall not be less than 2 by 8 inch (51 mm by 203 mm) nominal lumber. [11/2 inch by 71/4 inch (38 mm by 184 mm) actual dimension] or other construction material providing equal height and load capacity. Reinforcement shall be located between 32 inches (812.8 mm) and 391/4 inches (997 mm) above the finished floor flush with the wall framing. 3. Water closet reinforcement shall be installed on both side walls of the fixture, or one side wall and the back wall.
- 4. Shower reinforcement shall be continuous where wall framing is provided.
- 5. Bathtub and combination bathtub/shower reinforcement shall be continuous on each end of the bathtub and the back wall. Additionally, back wall reinforcement for a lower grab bar shall be provided with the bottom edge located no more than 6 inches (152.4 mm) above the bathtub rim.

WALL TYPES

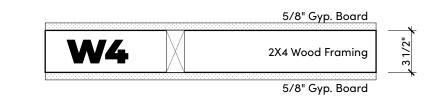

E0000000000000000000000000000000000000	5/8" Gyp. Board	
W4R	2X4 Wood Framing CLOSED CELL SPRAY FOAM	31/2"
1 HR RATED WALL	5/8" Typ X Gyp. Board	_

RATED WALL ASSEMBLIES SHALL EXTEND FROMTHE FOUNDATION TO THE UNDERSIDE OF THE ROOF SHEATHING

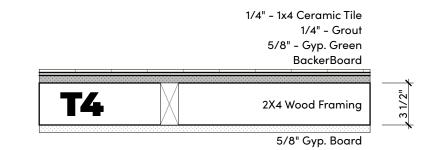

	5/8" Gyp. Board
F4	2X4 Wood Framing

7/8" 3-Coat Stucco, over (2) Layers Grade D Building Paper 15/32" Plywood Sheathing

|--|

(2) 7/8" Stucco Over 2-Layers 60-Minute Grade D Building Paper (1) 2 Layers 5/8" Typ X Gyp. Board

2 Layers 5/8" Typ X Gyp. Board

Assembly: AWC WS6-2.1

2 HR RATED WALL

RATED WALL ASSEMBLIES SHALL EXTEND FROMTHE FOUNDATION TO THE UNDERSIDE OF THE ROOF SHEATHING

Space For City Stamp



231 D ST, STE A DAVIS, CA 95616 **WWW.MWORK.SHOP**

Revision

MARK	DESCRIPTION	DATE
01	DESIGN REVIEW	
02	DESIGN REVIEW COMMENTS	

Project:

City Approvals:


KEY ROUTE ADDITION

1020 Key Route Blvd Albany, CA 94706 4/10/25 Issue Date

Job Number 24-040 Drawn

Approved

Scale Sheet Title: **FLOOR PLAN**

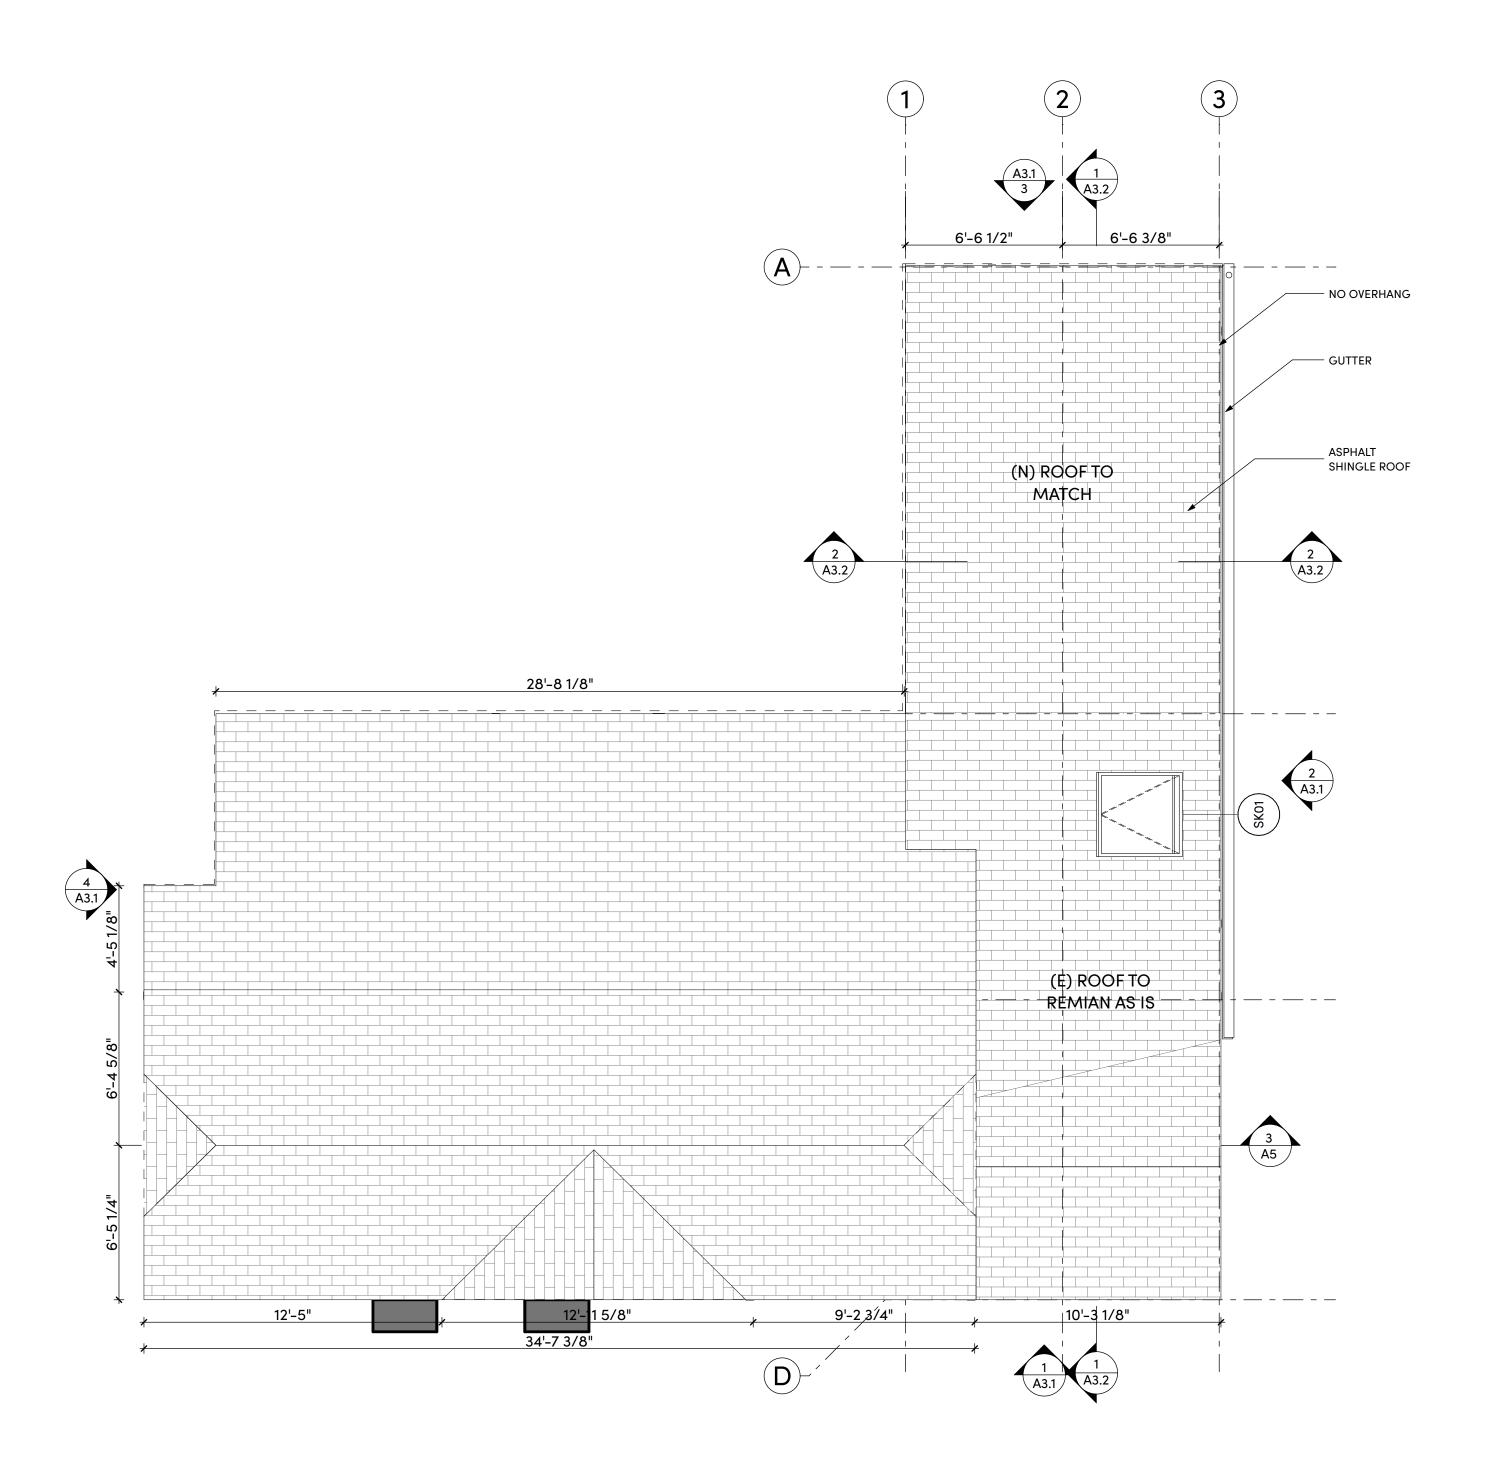




FLOOR PLAN NOTES

1. DO NOT SCALE DRAWINGS

- 2. SEE ELECTRICAL PLAN FOR ADDITIONAL INFORMATION
- 3. SEE STRUCTURAL PLANS FOR ADDITIONAL INFORMATION
- 4. COLUMN GRID DENOTED ALIGNMENT WITH OUTSIDE FACE OF STUD FRAMING
- 5. VERIFY WINDOWS, DOORS, APPLIANCES AND EQUIPMENT ROUGH OPENINGS WITH MANUFACTURERS PRODUCT DATA
- 6. ALL EXTERIOR WALL ARE WALL TYPE W6 UNLESS NOTED OTHERWISE
- 7. ALL INTERIOR WALLS ARE WALL TYPE W4 UNLESS NOTED OTHERWISE
- 8. 2-HOUR FIRE PROTECTED EAVES PROVIDED

GENERAL DETAILS

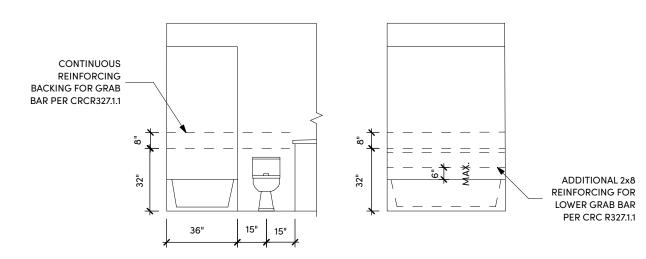

AS PER R327.1.1 Reinforcement for Grab Bars

At least one bathroom on the entry level shall be provided with reinforcement installed in accordance with this section. Where there is no bathroom on the entry level, at least one bathroom on the second or third floor of the dwelling shall comply with this section. 1. Reinforcement shall be solid lumber or other construction materials approved by the

enforcing agency. 2. Reinforcement shall not be less than 2 by 8 inch (51 mm by 203 mm) nominal lumber. [11/2 inch by 71/4 inch (38 mm by 184 mm) actual dimension] or other construction material providing equal height and load capacity. Reinforcement shall be located between 32 inches (812.8 mm) and 391/4 inches (997 mm) above the finished floor flush with the wall framing. 3. Water closet reinforcement shall be installed on both side walls of the fixture, or one side

wall and the back wall. 4. Shower reinforcement shall be continuous where wall framing is provided.

5. Bathtub and combination bathtub/shower reinforcement shall be continuous on each end of the bathtub and the back wall. Additionally, back wall reinforcement for a lower grab bar shall be provided with the bottom edge located no more than 6 inches (152.4 mm) above the bathtub rim.

ROOF PLAN NOTES

- Roof slopes >2:12 and <4:12 with asphalt shingles shall have two layers of 15 lb felt applied shingle style. (CBC 1507.2.2/CRC 905.2.2)
- Provide all under-floor areas with cross ventilation at 1/150 for the entire area with one vent within 3' of each corner. Screens over the openings shall have ≤1/4" openings. (CBC 1202/CRC R408)
- Provide attic access (22"x30") and under-floor access (18"x24") for new areas. (CBC 1208/R807.1/R408.4)

VENTILATION REQUIREMENTS:

TOTAL HABITABLE AREA = 294 SF GLAZING AREA = 40 SF > 8% of total area as per CRC R303.1 OPENABLE AREA = 27 SF > 4% of total area as per CRC R303.1

(N) FLAT CEILING: 88 SF NON VENTED CEILING: 519 SF

PROVIDE 1/150 OF THE AREA (88 SF) OF VENTILATION W/ 50% OF THE REQ. VENTILATION AREA (84.5 SQ.IN.) PROVIDED IN THE UPPER PORTION OF THE SPACE TO BE VENTILATED.

1 ROOF VENT @ 90 SQ. INCHES MODEL: VULCAN VDHR1224

PROVIDE VENTILATION COMPLYING WITH THE FOLLOWING: Enclosed attic and enclosed rafter spaces formed where ceilings are applied directly to the underside of roof framing members shall have cross ventilation for each separate space by ventilating openings. Blocking shall be arranged so as not to interfere with the movement of air. A min. of 1" clear airspace shall be provided between the insulation and the roof sheathing, the net free ventilating area shall not be less than 1/150 sf. of the area of the space ventilated, with 50% of the required ventilating area provided by ventilators located in the upper portion of the space to be ventilated. Openings shall be covered with corrosionresistant wire not exceeding 1/4" R806.2, .3 CRC/CBC 1202.2

*The whole house must comply with ASHRAE 62.2 ventilation standards. See CA Energy Code SS 150(o).

50 CFM REQUIRED AND WILL BE SATISFIED BY CONTINUOUS EXHAUST BATHROOM FAN.

REFERENCE TITLE 24 REPORT PAGE 6 of 7 for CALCULATION

Space For City Stamp



231 D ST, STE A **DAVIS, CA 95616 WWW.MWORK.SHOP**

Revision

MARK	DESCRIPTION	DATE
01	DESIGN REVIEW	
	·	



Project:

KEY ROUTE ADDITION

1020 Key Route Blvd Albany, CA 94706


4/3/25 Issue Date Job Number 24-040

Drawn Approved

Scale **Sheet Title: ROOF PLAN**

Existing Building Elevation - South

SCALE: 1/4" = 1'-0"

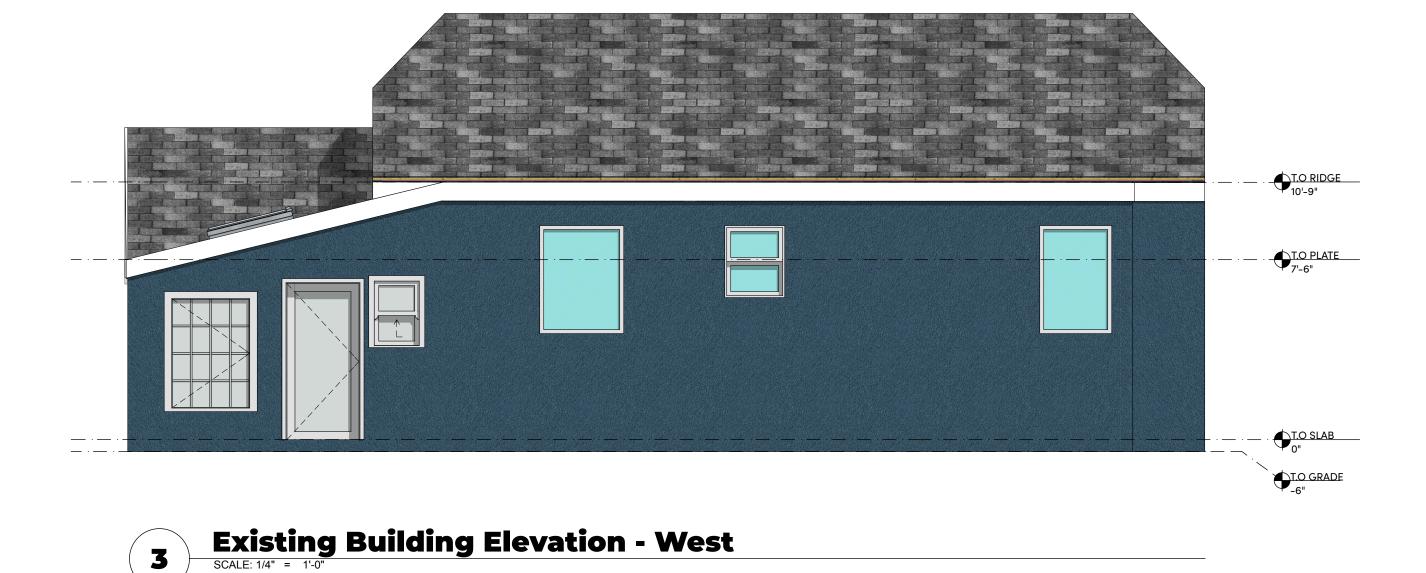

Existing Building Elevation - North

SCALE: 1/4" = 1'-0"



Existing Building Elevation - East

SCALE: 1/4" = 1'-0"



04 WINDOWS AND DOORS: WHITE / MATCH THE EXISTING STYLE



03 DOWNSPOUT AND GUTTER: WHITE



<u>02 ROOF:</u> ASPHALT SHINGLES STONE GRAY



01 SIDING: STUCCO PAINTED BLUE

Space For City Stamp

ARCHITECTURE 231 D ST, STE A

DAVIS, CA 95616 **WWW.MWORK.SHOP**

Project:

City Approvals:

ELEVATION / SECTIONS NOTES

(CBC 2113.9.2/CRC 1003.9.2)

CRC 905.2.2)

1202/CRC R408)

(CBC1202/CRC R806)

• Stucco shall be 7/8" thick and three coats applied over

• As per CBC 1403.2, minimum one layer of No.15 asphalt felt shall be attached to the studs or sheathing, with flashing as

described in Section 1404.4 (CBC 1403.2/CRC R703.2) Provide a spark arrestor for any new or existing chimney.

 Roof slopes >2:12 and <4:12 with asphalt shingles shall have two layers of 15 lb felt applied shingle style. (CBC 1507.2.2/

• Provide all under-floor areas with cross ventilation at 1/150 for the entire area with one vent within 3' of each corner. Screens over the openings shall have ≤1/4" openings. (CBC

• Attic areas shall have cross ventilation at 1/150 for the entire

area with 50% of the required vent area be ventilators located a min. of 3' above eave or cornice vents. Screens

over the openings shall have 1/16" to 1/4" openings.

• Provide attic access (22"x30") and under-floor access

(18"x24") for new areas. (CBC 1208/R807.1/R408.4))

Provide underfloor clearance of 18" from joists to earth and

12" clearance from girders to earth. (CBC 2304.12.1.1.1/CRC

• Contractor is not to wash the windows or remove labels prior

Provide weep screed. (CBC 2510.6/CRC R703.7)

approved wire lath and two layers of grade D building paper.

KEY ROUTE ADDITION

1020 Key Route Blvd Albany, CA 94706


Issue Date 4/3/25 Job Number 24-040

Drawn Approved

Scale

Sheet Title: EXISTING ELEVATIONS

to inspection and verification of U and SHGC properties

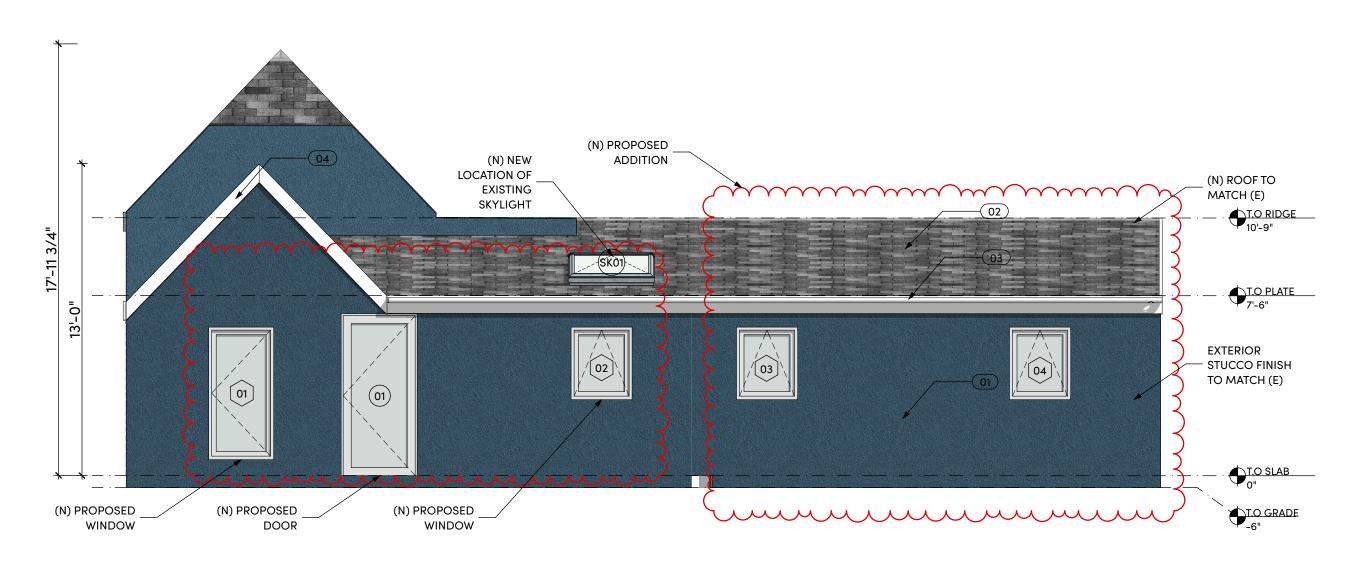


(E) ASPHALT SHINGLE ROOF . T.O RIDGE T.O PLATE T.O SLAB

Proposed Building Elevation - North

SCALE: 1/4" = 1'-0"



Proposed Building Elevation - East SCALE: 1/4" = 1'-0"

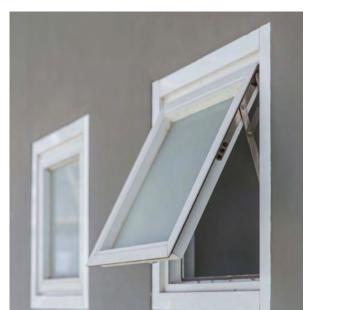

04 WINDOWS AND DOORS: WHITE / MATCH THE EXISTING STYLE



03 DOWNSPOUT AND GUTTER: WHITE



<u>02 ROOF:</u> ASPHALT SHINGLES STONE GRAY

ELEVATION KEYNOTES ELEVATION KEYNOTES

BLUE STUCCO SIDING

ELEVATION KEYNOTES

- DARK GRAY ASPHALT SHINGLE FINISH
- WHITE GUTTER AND DOWNSPOUNT
- WHITE PAINT ROOF TRIM



01 SIDING: STUCCO PAINTED BLUE

ELEVATION / SECTIONS NOTES


- Stucco shall be 7/8" thick and three coats applied over approved wire lath and two layers of grade D building paper. Provide weep screed. (CBC 2510.6/CRC R703.7)
- As per CBC 1403.2, minimum one layer of No.15 asphalt felt shall be attached to the studs or sheathing, with flashing as described in Section 1404.4 (CBC 1403.2/CRC R703.2)
- Provide a spark arrestor for any new or existing chimney. (CBC 2113.9.2/CRC 1003.9.2)
- Roof slopes >2:12 and <4:12 with asphalt shingles shall have two layers of 15 lb felt applied shingle style. (CBC 1507.2.2/ CRC 905.2.2)
- Provide all under-floor areas with cross ventilation at 1/150 for the entire area with one vent within 3' of each corner. Screens over the openings shall have ≤1/4" openings. (CBC 1202/CRC R408)
- Attic areas shall have cross ventilation at 1/150 for the entire area with 50% of the required vent area be ventilators located a min. of 3' above eave or cornice vents. Screens over the openings shall have 1/16" to 1/4" openings. (CBC1202/CRC R806)
- Provide attic access (22"x30") and under-floor access (18"x24") for new areas. (CBC 1208/R807.1/R408.4))
- Provide underfloor clearance of 18" from joists to earth and 12" clearance from girders to earth. (CBC 2304.12.1.1.1/CRC
- Contractor is not to wash the windows or remove labels prior to inspection and verification of U and SHGC properties

ARCHITECTURE

Space For City Stamp

231 D ST, STE A DAVIS, CA 95616 **WWW.MWORK.SHOP**

Revision

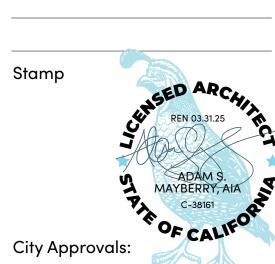

Project:

KEY ROUTE ADDITION

1020 Key Route Blvd Albany, CA 94706

Issue Date 4/3/25 Job Number 24-040


Approved Scale

Drawn

Sheet Title: PROPOSED **ELEVATIONS**




Building Section - E/W SCALE: 1/4" = 1'-0"

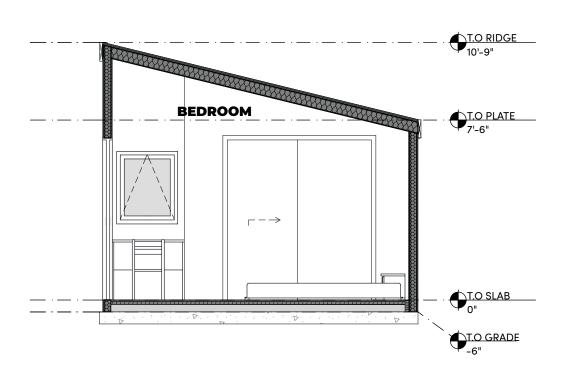

Building Section N/S

SCALE: 1/4" = 1'-0"

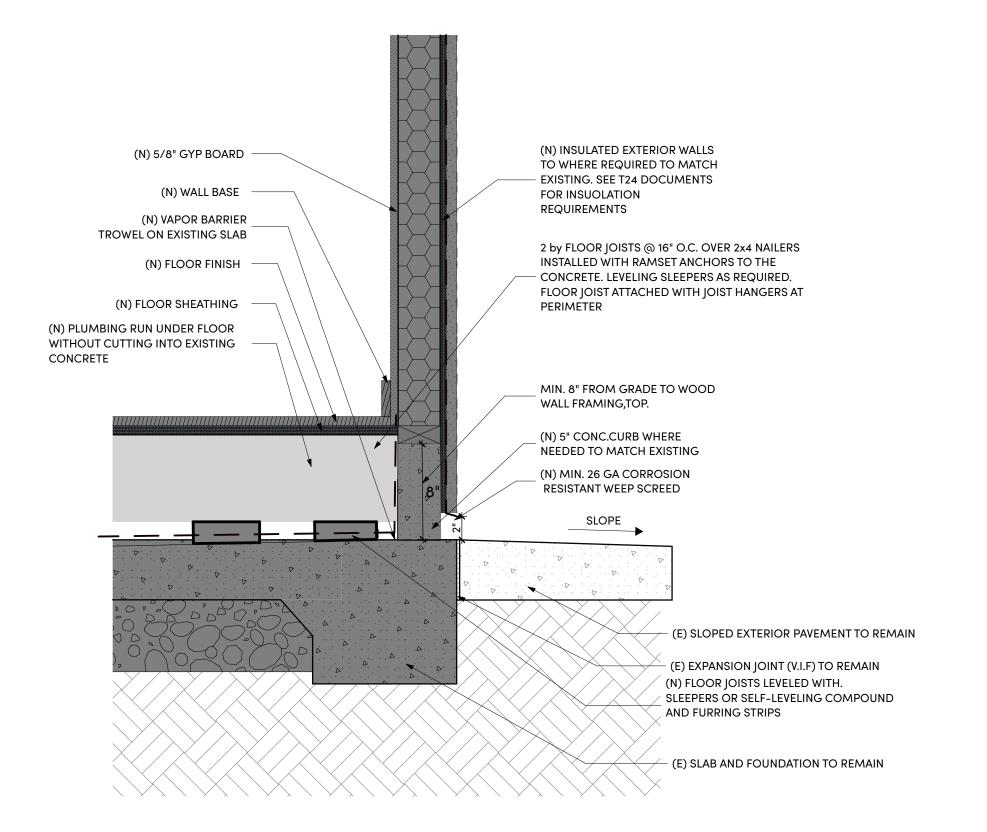

Typical Wall Section
SCALE: 1 1/2"= 1'-0"

ELEVATION / SECTIONS NOTES

- Stucco shall be 7/8" thick and three coats applied over approved wire lath and two layers of grade D building paper.
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- Provide attic access (22"x30") and under-floor access (18"x24") for new areas. (CBC 1208/R807.1/R408.4))
- Provide underfloor clearance of 18" from joists to earth and 12" clearance from girders to earth. (CBC 2304.12.1.1.1/CRC R317.1)
- Contractor is not to wash the windows or remove labels prior to inspection and verification of U and SHGC properties

Space For City Stamp



231 D ST, STE A DAVIS, CA 95616

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Revision

01	DESIGN REVIEW
	_
tamp	SED ARCH

STP



KEY ROUTE ADDITION


1020 Key Route Blvd Albany, CA 94706

Issue Date 4/3/25
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Approved Scale

Drawn

Sheet Title: SECTIONS

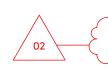


	WINDOW SCHEDULE													
	LOCATION	MANUFACTURER	OPERATION	WIDTH	HEIGHT	HEAD	SILL	MATERIAL	TEMP	EGRESS	NOTES	Area (Sq. Ft)		RMANCE
No	ROOM NAME		· · · · · · · · · · · · · · · · · · ·	~~~~~	· · · · · · · · · · · · · · · · · · ·	\(\)	~~~					` ' '	SHGC	U-Value
01	READING NOOK	ANDERSON E-SERIES	CASEMENT	2'-8"	5'-6"	6'-8"	1'-2"	ANDERSON E-SERIES WHITE	} □			14.67		
02	BATHROOM	ANDERSEN 100	AWNING	2'-6"	3'-0"	6'-8"	3'-8"	ANDERSON 100 - WHITE	\boxtimes			7.50		
03	KING BED	ANDERSEN 100	AWNING	2'-6"	3'-0"	6'-8"	3'-8"	ANDERSON 100 - WHITE				7.50		
04	KING BED	ANDERSEN 100	AWNING	2'-6"	3'-0"	6'-8"	3'-8"	ANDERSON 100 - WHITE				7.50		
05	BEDROOM	ANDERSEN 100	AWNING	2'-6"	3'-0"	6'-8"	3'-8"	ANDERSON 100 - WHITE				7.50		


WINDOW LEGEND									
ID	01	02	03	04	05 AWNING				
OPERATION	CASEMENT	AWNING	AWNING	AWNING					
STYLE	NO GRID								
VIEW		2'-6"	2'-6"	2'-6"	2'-6"				
DIMS	2'-8"×5'-6"	2'-6"×3'-0"	2'-6"×3'-0"	2'-6"×3'-0"	2'-6"×3'-0"				

			D	OOR LEGEND			
ID	01	02	03	04	05	06	07
OPERATION	SWING	SWING	SWING	SLIDING FOLDING	SWING	SLIDING	SLIDING
STYLE	FLUSH	FLUSH	FLUSH	LOUVERED	FLUSH	FLUSH	FLUSH
VIEW	3'-0"	2'-6"	2'-6"	5'-0"	2'-5 1/4"	6'-0"	6'-0"
UNIT SIZE	3'-0"×6'-8"	2'-6"×6'-8"	2'-6"×6'-8"	5'-0"×6'-8"	2'-5 1/4"×6'-8"	6'-0"×6'-8"	6'-0"×6'-8"

DOOR SCHEDULE											
ID ROOM N	DOOM NAME	TYPE WIDTH	HEIGHT		MATL	GLZ	GLAZING PERFORMANCE		FIRE	NOTES	
	ROOM NAME	IIPE	WIDIR	ПЕІВПІ	DR. THK.	IVIAIL	GLZ	U-Value	SHGC	FIRE	NOTES
01	LIVING AREA	SWING	3'-0"	6'-8"	13/4"	WOOD	\boxtimes	0.3	0.23		
02	LIVING AREA	SWING	2'-6"	6'-8"	13/4"	WOOD					
03	LIVING AREA	SWING	2'-6"	6'-8"	13/4"	WOOD					
04	LAUNDRY	FOLDING	5'-0"	6'-8"	13/4"	WOOD					
05	BATHROOM	SWING	2'-5 1/4"	6'-8"	13/4"	WOOD					
06	BEDROOM	SLIDING	6'-0"	6'-8"	13/4"	WOOD	\boxtimes	0.3	0.23		
07	CLOEST	SLIDING	6'-0"	6'-8"	13/4"	WOOD					

EXISTING WINDOW PHOTO - FACADE

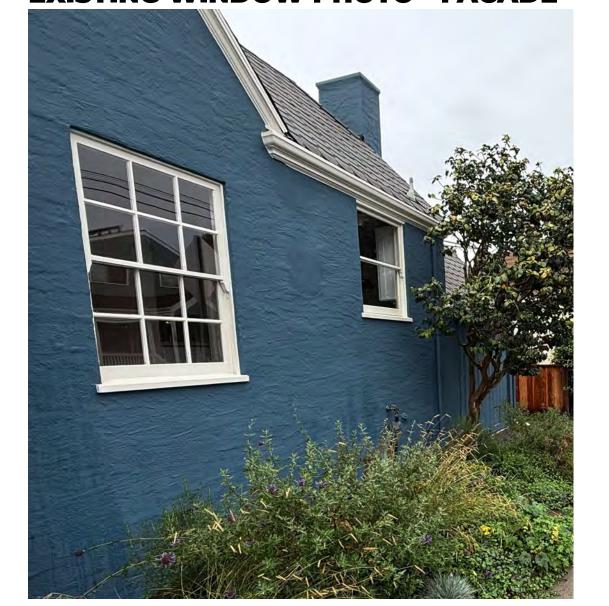

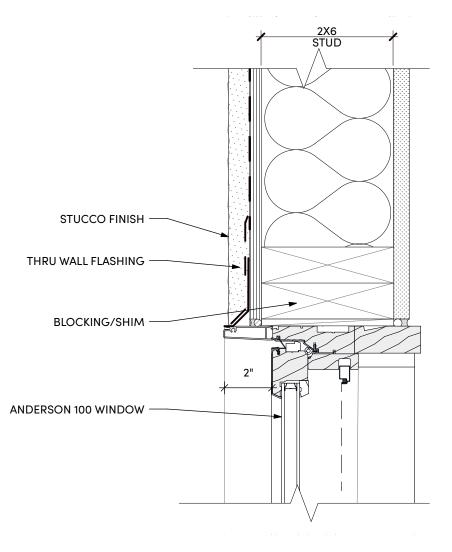



WINDOW REPLACEMENT GENERAL NOTES

- If ≤75 sq.ft. is replaced, new windows shall meet T24 REQ. If > 75 sq.ft. new windows shall have max. U-factor of 0.32 and max. SHGC of 0.25. (CEES 150.2(b)).
- Windows replaced in bedrooms shall meet the egress requirements of a min. 20" clear width, min. 24" clear height when open, min. 5.7 sq.ft. of openable area (5.0 sq.ft. for grade level rooms), and max. height of 44" from the finished floor to the bottom of the clear opening. (CBC 1030 and CRC
- Where the window sill is located more than 72" above the exterior finished grade, any window located less than 24" above the finished floor on the interior shall be either fixed glazing or have a protective guardrail with openings less than 4". (CBC 1015.1 and CRC R312.2)
- Smoke alarms shall be provided in all sleeping rooms and adjacent hallways, multi-levels, and basements. Existing smoke alarms shall be replaced if older than 10 years. Newly installed smoke alarms shall have a 10-year battery. (CBC 907.2.10, CRC 314)
- CO alarm shall be installed in hallways adjacent to bedrooms and each level. (CRC 315)

TEMPERED GLAZING SHALL BE INSTALLED IN THE FOLLOWING LOCATIONS (2022 CBC 2406.4/CRC R308.4:)

- In the same plane of a door in the closed position & within 2' of either side of the door.
- On a wall perpendicular to the plane of a door in a closed position & within 24" of the hinge side of the door and on the in-swinging side.
- Adjacent to a bottom stair landing where glazing is less than 36" above the landing and within 60" horizontally of the landing.
- Adjacent to stairs where glazing is located less than 36" above the plane of the adjacent walking
- In a wall enclosing a tub/shower where the bottom exposed edge of the glazing is <60" above the
- standing surface and drain inlet.
- Within 60" of a tub/shower where the glazing is less than 60" above the walking surface.
- Any glazing meeting all the following conditions: individual pane > 9 square feet
 - bottom edge is less than 18" above floor
 - top edge is > 36" above the finished floor

 Where a walking surface is within 36" horizontally of the glazing WINDOWS CLOSE TO SHOWER OR BATH TUB SHALL BE OF TEMPERED GLASS

WINDOW SCHEDULE NOTES:

- Windows in schedule marked EGRESS to comply with emergency egress requirements per 2022 CRC Sect. R310.2 Emergency escape and rescue openings
- Windows in schedule will all match the existing window style

Space For City Stamp



231 D ST, STE A DAVIS, CA 95616 **WWW.MWORK.SHOP**

Revision

DESIGN REVIEW

02 DESIGN REVIEW COMMENTS



Project:

KEY ROUTE ADDITION

1020 Key Route Blvd Albany, CA 94706

Issue Date

Job Number Drawn

Approved Scale

Sheet Title: DOOR / WINDOW SCHEDULES

1' = 1'-0", 1/8" = 1'-0", 1/4"